### THE BOARD OF SUPERVISORS OF THE COUNTY OF STANISLAUS

A A A A A ACTION AGENDA SUMI	MARY
DEPT: Public Works //////	BOARD AGENDA # *C-1
Urgent ☐ Routine ☐	AGENDA DATE January 25, 2011
CEO Concurs with Recommendation YES NO (Information Attached)	4/5 Vote Required YES NO
SUBJECT:	
Approval to Adopt the Plans and Specifications for Federa at Crows Landing Road Traffic Signal Upgrade Project" a Program	al Project No. HSIP-5938(160) Titled "Hatch Road and included in the Highway Safety Improvement
STAFF RECOMMENDATIONS:	
<ol> <li>Adopt the Plans and Specifications for Federal Project Crows Landing Road Traffic Signal Upgrade Project," Program, and authorize a bid opening.</li> </ol>	ct No. HSIP-5938(160) Titled "Hatch Road at ' included in the Highway Safety Improvement
2. Direct the Department of Public Works to set the bid o	ppening date and time.
<ol><li>Direct the Public Works Department staff to post the n law.</li></ol>	notice inviting bids to trade journals as required by
FISCAL IMPACT:	
The total anticipated cost for this project is \$625,000. contribute \$419,633 to this project. The remaining project County Public Works Road Fund. There are funds availaburpose.	ct costs of \$205,367 will be covered by Stanislaus
BOARD ACTION AS FOLLOWS:	No. 2011-070
On motion of Supervisor O'Brien , Second approved by the following vote, Ayes: Supervisors: O'Brien, Chiesa, Withrow, DeMartini, an Noes: Supervisors: None Excused or Absent: Supervisors: None Abstaining: Supervisor: None  1) X Approved as recommended 2) Denied	nd Chairman Monteith

ATTEST:

CHRISTINE FERRARO TALLMAN, Clerk

File No.

Approval to Adopt the Plans and Specifications for Federal Project No. HSIP-5938(160) Titled "Hatch Road at Crows Landing Road Traffic Signal Upgrade Project" and included in the Highway Safety Improvement Program

### DISCUSSION:

The proposed improvements to the Hatch Road at Crows Landing at this intersection will consist of replacing outdated traffic signals that are approximately 42 years old with new relocated traffic signals. The project will remove left turn signal poles located in medians and replace approximately 300 lineal feet of raised concrete medians on Crows Landing Road.

Intersection improvements in this project include but are not limited to:

- Installation of replacement signal poles.
- Installation of concrete foundations for replacement signal poles.
- Re-striping of traffic lanes on northbound and southbound Crows Landing Road to create right turn lanes within the existing pavement.
- Replacement of raised concrete medians on Crows Landing Road.
- Installation of ADA compliant ramps.
- Installation of new curb and gutter with increased radius returns.
- Upgrading of traffic signs to meet current design standards.
- Installation of traffic signal detector loops.

The following tentative project schedule is provided:

Adopt Plans & Specifications: Tuesday, January 25, 2011

Advertise: Monday, January 31, 2011

Monday, February 07, 2011 Monday, February 14, 2011

Bid Opening: Wednesday, March 02, 2011

Estimated Contract Award: Tuesday, March 22, 2011
Estimated Notice to Proceed: Tuesday, April 12, 2011
Estimated End Construction: Thursday, June 02, 2011

On April 22, 2010, Caltrans issued a National Environmental Policy Act (NEPA) Categorical Exemption/Exclusion determination for this project.

On June 2, 2009, the Board of Supervisors awarded the preliminary engineering and design contract to Delamare – Fultz Engineering and Surveying of Modesto, California.

This project is exempt from the California Environmental Quality Act, Class 1, California Code of Regulations, Title 14, #15301 (Existing Facilities). Stanislaus County Public Works Department filed a CEQA Categorical Exemption notice on December 15, 2010, with the Stanislaus County Clerk Recorder.

Department staff will brief the South Modesto Municipal Advisory Council (MAC) on this project during their February 2011 regular meeting. Historically, traffic safety along

Approval to Adopt the Plans and Specifications for Federal Project No. HSIP-5938(160) Titled "Hatch Road at Crows Landing Road Traffic Signal Upgrade Project" and included in the Highway Safety Improvement Program

Crows Landing Road has been a primary concern of the South Modesto MAC and local area residents.

### **POLICY ISSUES:**

The recommended actions are consistent with the Board's priorities of providing a Safe community, a Healthy Community and a Well Planned Infrastructure System by improving intersection safety in this area of Stanislaus County.

### **STAFFING IMPACT:**

There is no staffing impact associated with this item.

### **CONTACT PERSON:**

ATTACHMENTS RYALLASLE FROM YOUR CLERK

Matt Machado, Public Works Director. Telephone: (209) 525-4130.

DB:jg
L:\ROADS\9287\_\_\_Crows Landing Rd at Hatch Rd traffic Signal upgrade\Design\Board Items\02\_Adopt Plans and Specs

### COUNTY OF STANISLAUS GENERAL NOTES:

- 1. ALL ELEVATIONS ARE BASED ON NAVD88 DATUM, CITY OF MODESTO BENCHMARK D14-647, BRASS DISC IN SIGNAL LIGHT BASE AT NORTHWEST CORNER OF HATCH ROAD AND CROWS LANDING ROAD. NAVD88 ELEVATION= 87.64
- 2. THE CONTRACTOR SHALL COMPLY WITH THE REQUIREMENTS OF CHAPTER 6, SECTIONS 6705, 6706, AND
- 3. THE CONTRACTOR SHALL SUBMIT TO THE COUNTY FOR APPROVAL A DETAILED PLAN SHOWING THE DESIGN OF SHORING, BRACING, SLOPING, OR OTHER PROVISIONS TO BE MADE FOR WORKER PROTECTION FOR ALL AREAS TO BE EXCAVATED TO A DEPTH OF FIVE FEET OR MORE. IF THE PLAN VARIES FROM THE SHORING SYSTEM STANDARDS, THE PLAN SHALL BE PREPARED BY A REGISTERED CIVIL OR STRUCTURAL
- 4. NO WORK CAN BEGIN WITHOUT AN APPROVED AND SIGNED SET OF IMPROVEMENT PLANS
- 5. CONTRACTORS SHALL BE RESPONSIBLE FOR THE LOCATION AND PROTECTION OF ALL EXISTING PREVIOUSLY INSTALLED UNDERGROUND FACILITIES. INCLUDING GAS, ELECTRICAL POWER, TELEPHONE, TV CABLE, IRRIGATION PIPELINES, SANITARY SEWER LINES, STORM DRAIN LINES, WATER AND OTHERS WHICH MAY BE IN THE AREA OF CONSTRUCTION. CONTRACTOR SHALL BE RESPONSIBLE FOR THE NOTIFICATION OF THE VARIOUS UTILITY COMPANIES PRIOR TO COMMENCEMENT OF WORK. PRIOR TO EXCAVATING NEAR ANY UNDERGROUND UTILITIES, CALL U.S.A. AT LEAST FORTY- EIGHT (48) HOURS IN ADVANCE AT PHONE (800) 227-2600.
- 6. ALL UTILITY INFORMATION SHOWN ON THESE PLANS IS BASED UPON SURFACE EVIDENCE LOCATED IN THE FIELD AND THE RECORDS OF THE VARIOUS UTILITY COMPANIES:

LEGEND:

**PROPOSED** 

CONCRETE

CURB AND GUTTER

GAS > GAS LINE

√ 10" W ➤ WATER LINE

**ASPHALT PAVEMENT** 

- 7. THE PROPERTY IS SERVED BY THE FOLLOWING UTILITY COMPANIES: ELECTRICAL POWER......TURLOCK IRRIGATION DISTRICT IRRIGATION......TURLOCK IRRIGATION DISTRICT TELEPHONE.....AT&T GAS......PACIFIC GAS & ELECTRIC SANITARY SEWER......CITY OF MODESTO WATER.....CITY OF MODESTO STORM DRAIN......STANISLAUS COUNT CABLE TELEVISION......COMCAST CABLE
- 8. WHERE THE PLANS AND SPECIFICATIONS DESCRIBE PORTIONS OF THE WORK IN GENERAL TERMS BUT NOT IN COMPLETE DETAIL, IT IS UNDERSTOOD THAT ONLY THE BEST GENERAL PRACTICE IS TO PREVAIL AND THAT ONLY MATERIALS AND WORKMANSHIP OF THE FIRST QUALITY ARE TO USED.
- 9. CONTRACTOR WILL BE RESPONSIBLE FOR PROVIDING CONSTRUCTION STAKING
- 10. THESE PLANS HAVE BEEN CHECKED BY THE COUNTY OF STANISLAUS AND/OR ITS AUTHORIZED REPRESENTATIVE BUT SUCH CHECKING AND/OR APPROVAL DOES NOT RELIEVE CONTRACTOR FROM HIS/HER RESPONSIBILITY TO CORRECT ERRORS, OMISSIONS OR MAKE CHANGES REQUIRED BY CONDITIONS DISCOVERED IN THE FIELD DURING
- 11. RELOCATION OF DESIGNED UTILITY SYSTEMS MORE THAN 25' MUST BE REVIEWED BY THE ENGINEERING DEPARTMENT PRIOR TO CONSTRUCTION AND SHALL BE ACCURATELY SHOWN ON REVISED PLANS STAMPED AND SIGNED BY COUNTY STAFF PRIOR TO THE INSTALLATION OF THE IMPROVEMENTS.
- 12. HOUSE SERVICES, FIRE HYDRANT LATERALS, GAS AND TELEPHONE LINES, AND ALL OTHER UNDERGROUND UTILITIES SHALL BE INSTALLED PRIOR TO CURB, GUTTER. AND SIDEWALK CONSTRUCTION AND STREET PAVING.
- 13. ALL LINES ABANDONED DURING CONSTRUCTION SHALL BE REMOVED.
- 14. ALL EXISTING UNDERGROUND UTILITIES MAY NOT BE SHOWN. THE CONTRACTOR SHALL TAKE PRECAUTIONARY MEASURES TO PROTECT THESE UTILITIES. THE CONTRACTOR SHALL DO NO EXCAVATION UNTIL ALL UTILITY COMPANIES HAVE BEEN GIVEN THE OPPORTUNITY TO MARK THEIR FACILITIES IN
- 15. FOR ALL PROJECTS, REGARDLESS OF SIZE, THE CONTRACTOR SHALL IMPLEMENT BEST MANAGEMENT PRACTICES (BMPs) TO ELIMINATE OR MINIMIZE STORM WATER POLLUTION DISCHARGE CAUSED BY CONSTRUCTION.
- 16. WATERIAL TESTING:
  - A) ALL INDEPENDENT MATERIAL TESTING AND INSPECTION CALLED FOR BY THE COUNTY ENGINEER SHALL BE FURNISHED AND PAID FOR BY COUNTY.
  - B) CONTRACTOR SHALL FURNISH MATERIAL CERTIFICATIONS OF PRE-MANUFACTURED MATERIAL WHEN CALLED FOR BY COUNTY ENGINEER.
- 17. STREET STRIPING SHALL INCLUDE STOP BARS, CENTERLINE STRIPING OR MARKERS, CROSSWALKS AND ALL OTHER MARKINGS IF REQUIRED BY THE COUNTY ENGINEER AND SHOWN ON THESE PLANS. STRIPING SHALL BE DONE WITH THERMOPLASTIC AND REFLECTIVE MARKERS.
- 18. ALL TRENCHES SHALL BE BACK FILLED IN ACCORDANCE WITH COUNTY STANDARDS.
- 19. WHEN WIDENING THE PAVEMENT ON AN EXISTING ROAD, THE EXISTING PAVEMENT SHALL BE CUT TO A NEAT LINE AND REMOVED BACK TO AN EXISTING ADEQUATE STRUCTURAL SECTION, OR TO THE ORIGINAL ROAD SECTION. AN EXPLORATORY TRENCH, OR POT-HOLING, MAY BE REQUIRED TO DETERMINE THE LIMITS OF PAVEMENT REMOVAL.
- 20. CONTRACTOR SHALL MAKE ARRANGEMENTS WITH ADJACENT PROPERTY OWNERS AS NECESSARY IF STAGING AREA IS DESIRED. CONTRACTOR SHALL PROVIDE COPY OF ENCROACHMENT AGREEMENT WITH SAID PROPERTY OWNERS TO COUNTY PRIOR TO MOBILIZATION.




CONTRACTOR SHALL CALL UNDERGROUND SERVICE ALERT (800) 227-2600, PRIOR TO ANY EXCAVATION FOR VERIFICATION OF UNDERGROUND UTILITY LOCATIONS.

IMPROVEMENT PLANS FOR

# HATCH ROAD AT CROWS LANDING ROAD

TRAFFIC SIGNAL UPGRADE PROJECT FOR STANISLAUS COUNTY LYING IN SECTIONS 4,5,8,8 9

T.4S., R.9E., M.D.B.&M., STANISLAUS COUNTY, CALIFORNIA

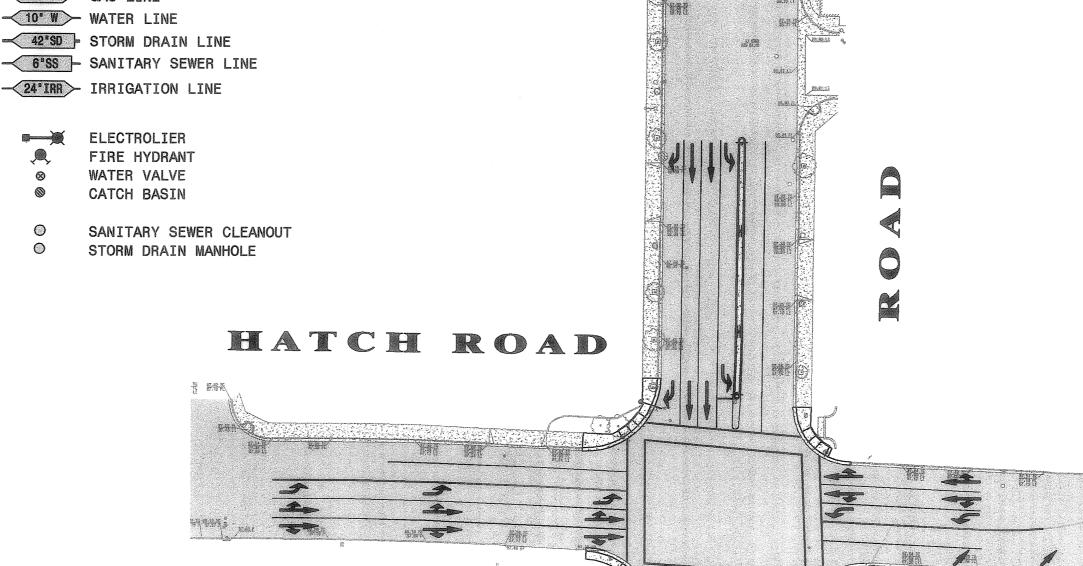

SCALE


SITE PLAN

SCALE: 1"=60'

CITY OF MODESTO - PERMIT CONSTRUCTION NOTES
(PER CHAPTER 2 OF THE CITY OF MODESTO STANDARDS)

- ALL MATERIAL AND WORK SHALL CONFORM TO CITY OF MODESTO SPECIFICATIONS AND PLANS. THE IMPROVEMENTS ARE SUBJECT TO THE INSPECTION AND APPROVAL OF THE ENGINEERING & TRANSPORTATION DEPARTMENT. CONTACT THE CONSTRUCTION ADMINISTRATION OFFICE AT 577-5452 TWO WORKING DAYS (48 HOURS) PRIOR TO THE START OF ANY WORK TO ARRANGE FOR INSPECTION.
- 2. THE CONTRACTOR OR DEVELOPER SHALL OBTAIN AN ENCROACHMENT PERMIT PRIOR TO THE START OF ANY WORK. NO WORK CAN BEGIN WITHOUT AN APPROVED AND SIGNED SET OF IMPROVEMENT PLANS.
- PRIOR TO EXCAVATING NEAR ANY UNDERGROUND UTILITIES, CALL U.S.A. AT LEAST FORTY-EIGHT (48) HOURS IN ADVANCE AT PHONE (800) 642-2444 OR (800) 227-2600.
- THESE PLANS HAVE BEEN CHECKED BY THE CITY OF MODESTO AND/OR ITS AUTHORIZED REPRESENTATIVE, BUT SUCH CHECKING AND/OR APPROVAL DOES NOT RELIEVE THE DEVELOPER AND CONTRACTOR FROM HIS/HER RESPONSIBILITY TO CORRECT ERRORS. OMISSIONS OR MAKE CHANGES REQUIRED BY CONDITIONS DISCOVERED IN THE FIELD DURING THE COURSE OF CONSTRUCTION
- CONTRACTOR SHALL CONTROL DUST AT ALL TIMES DURING CONSTRUCTION AS REQUIRED BY THE CITY OF MODESTO AND THE REGIONAL AIR QUALITY CONTROL BOARD.
- RELOCATION OF DESIGNED UTILITY SYSTEMS MORE THAN 25' MUST BE REVIEWED BY THE PUBLIC WORKS DEPARTMENT PRIOR TO CONSTRUCTION AND SHALL BE ACCURATELY SHOWN ON REVISED PLANS STAMPED AND SHALL BE APPROVED BY CITY STAFF AND THE DESIGN ENGINEER PRIOR TO THE INSTALLATION OF THE IMPROVEMENTS.
- ALL CONSTRUCTION STAKING FOR CURB, GUTTER, AND SIDEWALK, SANITARY SEWERS, STORM DRAINS, WATER LINES, FIRE HYDRANTS, AND ELECTROLIERS, ETC. SHALL BE DONE UNDER THE DIRECTION OF A REGISTERED CIVIL ENGINEER OR AND INDIVIDUAL LICENSED TO PERFORM LAND SURVEYING UNDER THE CALIFORNIA BUSINESS & PROFESSIONS CODE.
- ALL EXISTING UNDERGROUND UTILITIES MAY NOT BE SHOWN. THE CONTRACTOR SHALL TAKE PRECAUTIONARY MEASURES TO PROTECT THESE UTILITIES. THE CONTRACTOR SHALL DO NO EXCAVATION UNTIL ALL UTILITY COMPANIES AND THE CITY OF MODESTO HAVE BEEN NOTIFIED & GIVEN OPPORTUNITY TO MARK THEIR FACILITIES IN THE FIELD.
- HOUSE SERVICES, FIRE HYDRANT LATERALS, GAS AND TELEPHONE LINES, AND ALL OTHER UNDERGROUND UTILITIES SHALL BE INSTALLED PRIOR TO CURB, GUTTER, AND SIDEWALK CONSTRUCTION AND STREET PAVING.
- 10. ALL LINES ABANDONED DURING CONSTRUCTION SHALL BE REMOVED.
- 11. FOR ALL PROJECTS, REGARDLESS OF SIZE, THE CONTRACTOR SHALL IMPLEMENT BEST MANAGEMENT PRACTICES (BMPs) TO ELIMINATE OR MINIMIZE POLLUTION DISCHARGE CAUSED BY CONSTRUCTION (SEE SECTION 16).
- 12. MATERIAL TESTING
- A) ALL INDEPENDENT MATERIAL TESTING AND INSPECTION CALLED FOR BY THE CITY ENGINEER SHALL BE FURNISHED AND PAID FOR BY THE DEVELOPER OR CONTRACTOR. B) SUB-GRADE TESTING FOR R-VALUES IS REQUIRED PRIOR TO THE INSTALLATION OF BASE ROCK.
- C) CONTRACTOR SHALL FURNISH MATERIAL CERTIFICATIONS OF PRE-MANUFACTUERD MATERIAL WHEN CALLED FOR BY THE CITY ENGINEER.
- 13. STREET STRIPING SHALL INCLUDE STOP BARS, CENTERLINE STRIPING OR MARKERS, CROSSWALKS AND ALL OTHER MARKINGS REQUIRED BY THE CITY ENGINEER. STRIPING SHALL BE DONE WITH THERMOPLASTIC AND REFLECTIVE MARKERS.
- 14. ALL TRENCHES SHALL BE BACKFILLED IN ACCORDANCE WITH CITY STANDARDS.
- 15. WHEN WIDENING THE PAVEMENT ON AN EXISTING ROAD, THE EXISTING PAVEMENT SHALL BE CUT TO A NEAT LINE AND REMOVED BACK TO AN EXISTING ADEQUATE STRUCTURAL SECTION. OR TO THE ORIGINAL ROAD SECTION. AN EXPLORATORY TRENCH, OR POT-HOLING, MAY BE REQUIRED TO DETERMINE THE LIMITS OF PAVEMENT REMOVAL.
- 16. EXISTING CURB AND SIDEWALK WITHIN THE PROJECT LIMITS THAT ARE DAMAGED OR DISPLACED, EVEN THOUGH THEY WERE NOT TO BE REMOVED. SHALL BE REPAIRED OR REPLACED PER CITY STANDARD DETAILS EVEN IF DAMAGE OR DISPLACEMENT OCCURRED PRIOR TO ANY WORK PERFORMED BY THE CONTRACTOR.
- 17. ASBESTOS CEMENT PIPE (ACP) OR FITTINGS SHALL NOT BE USED WITHIN THE CITY OF
- 18. PRIOR TO TRENCHING FOR ANY SEWER, WATER, OR STORM DRAIN PIPE, THE CONTRACTOR SHALL VERIFY, IN THE FIELD, THE SIZE AND LOCATION OF THE EXISTING PIPE AT THE POINT OF CONNECTION. ANY DEVIATION FROM THE PLANS SHALL BE RESOLVED BY THE DESIGN ENGINEER PRIOR TO TRENCHING.
- 19. MANHOLES, VALVES, CLEAN OUTS, ETC. SHALL BE BROUGHT TO FINISH GRADE BY THE INDERGROUND CONTRACTOR AFTER THE FINAL PAVING COURSE IS PLACED.
- 20. FOR PIPES GREATER THAN 30" ON SEWER AND 36" ON STORM DRAIN, 60" INSIDE DIAMETER, MANHOLES SHALL BE USED.
- 21. STREET CLOSURE OR LANE CLOSURE WILL REQUIRE A TRAFFIC CONTROL PLAN AND THE DESIGNATION OF A QUALIFIED INDIVIDUAL FOR ITS IMPLEMENTATION AND SAFE MAINTENANCE.

APPROVED BY STANISLAUS COUNTY PUBLIC WORKS DEPARTMENT: THESE PLANS HAVE BEEN CHECKED BY THE STANISLAUS COUNTY DEPARTMENT OF PUBLIC WORKS AND/OR AUTHORIZED REPRESENTATIVE, BUT SUCH CHECKING AND/OR APPROVAL DOES NOT RELIEVE THE CONTRACTOR FROM HIS/HER RESPONSIBILITY TO CORRECT ERRORS, OMISSIONS, OR MAKE CHANGES REQUIRED BY CONDITIONS DISCOVERED IN THE FIELD DURING THE COURSE OF

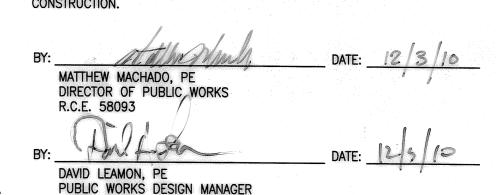

n DELAMARE-FULTZ **ENGINEERING AND SURVEYING** 3421 TULLY ROAD SUITE J MODESTO, CA. 95350

R.C.E. 60434

RCE No. 53311

(EXP. 06-30-11)

TELEPHONE (209) 529-7450 David J. Hobers Nov. 19, 2010

MODESTO

NOTES, SPECIFICATIONS, AND DETAILS

STREET GEOMETRY/LAYOUT PLAN

STREET ASPHALT OVERLAY PLAN

SIGNAGE AND STRIPING PLAN

EROSION CONTROL PLAN

THE CITY OF MODESTO PERMIT CONSTRUCTION NOTES

SHOWN ON THIS SHEET ARE FROM THE CTIY OF

APPLICABLE TO WATER SYSTEM WORK ONLY. ALL

OTHER WORK SHOWN ON THESE PLANS ARE COVERED

MODESTO STANDARD SPECIFICATIONS AND ARE

BY COUNTY OF STANISLAUS STANDARDS.

VICINITY MAP

COVER SHEET

UTILITY PLAN

SIGNAL PLAN

NOTE TO CONTRACTOR:

SHEET TS-2 - SIGNAL SALVAGE PLAN

DEMOLITION PLAN

NOT TO SCALE

SHEET INDEX

CIVIL PLANS:

SHEET C-8

SHEET C-9

SIGNAL PLANS:


SHEET TS-1 -


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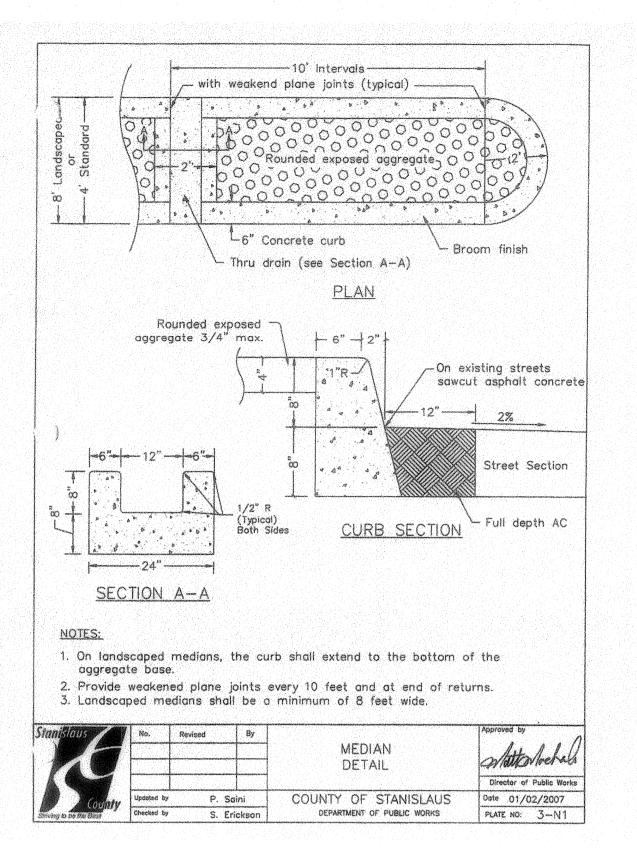
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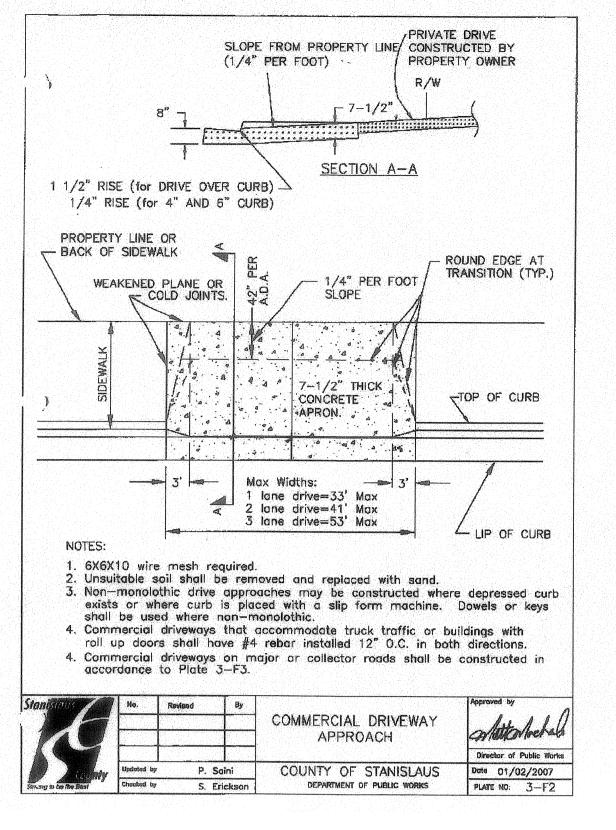
SHEETS


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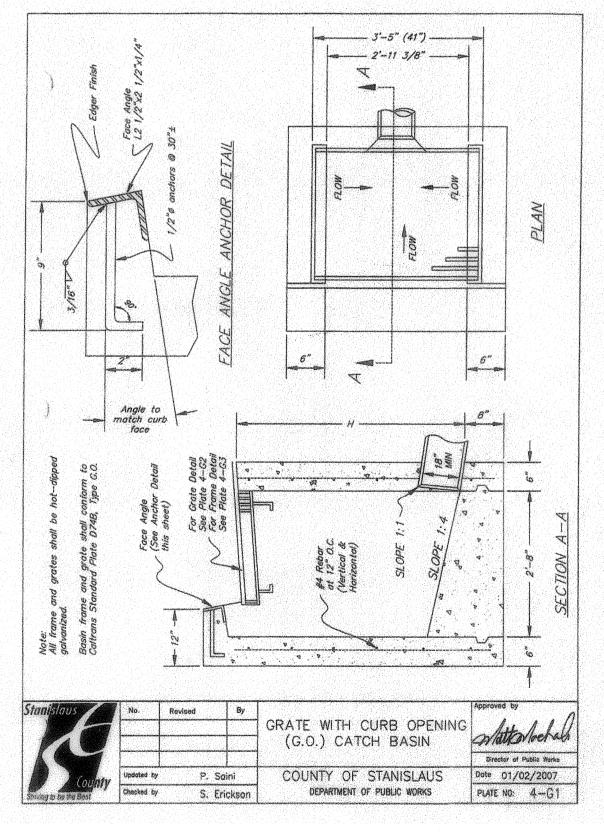








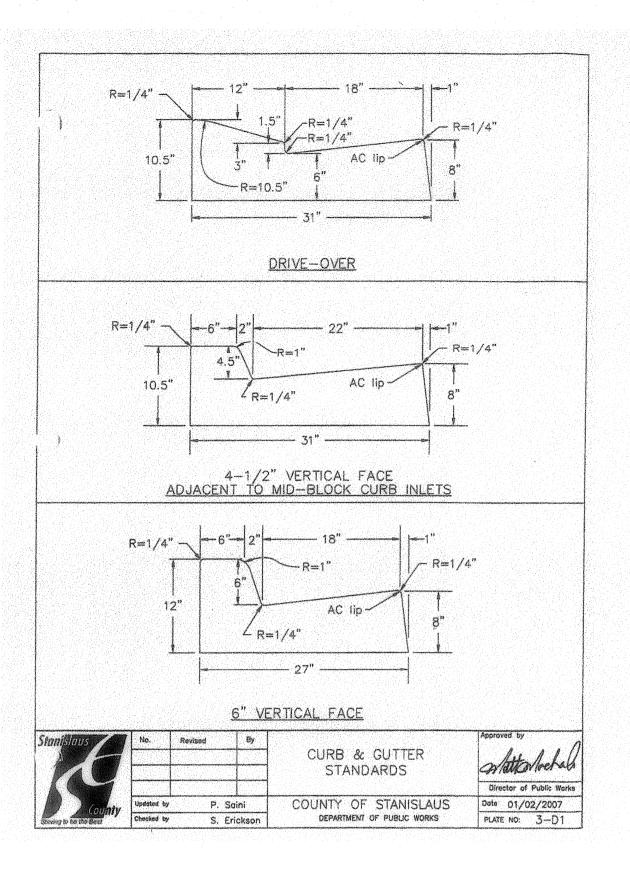

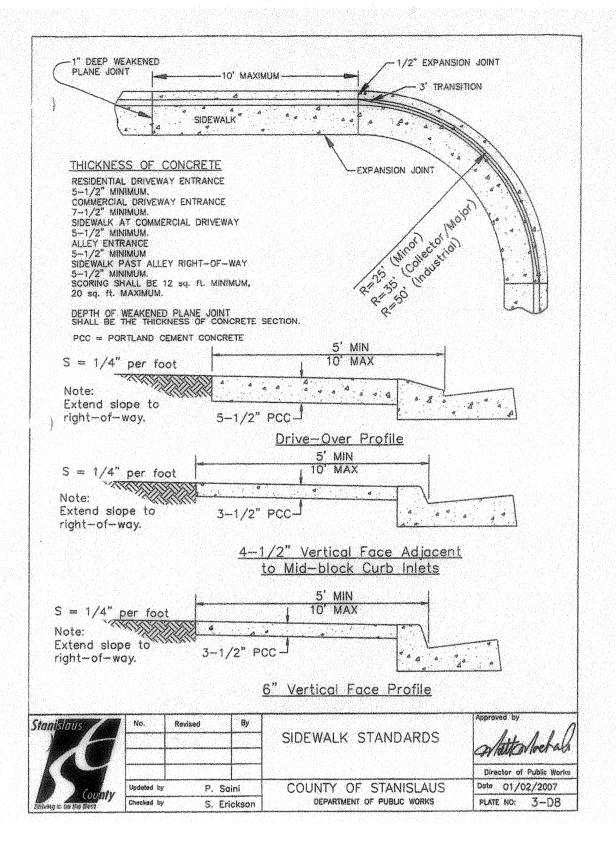

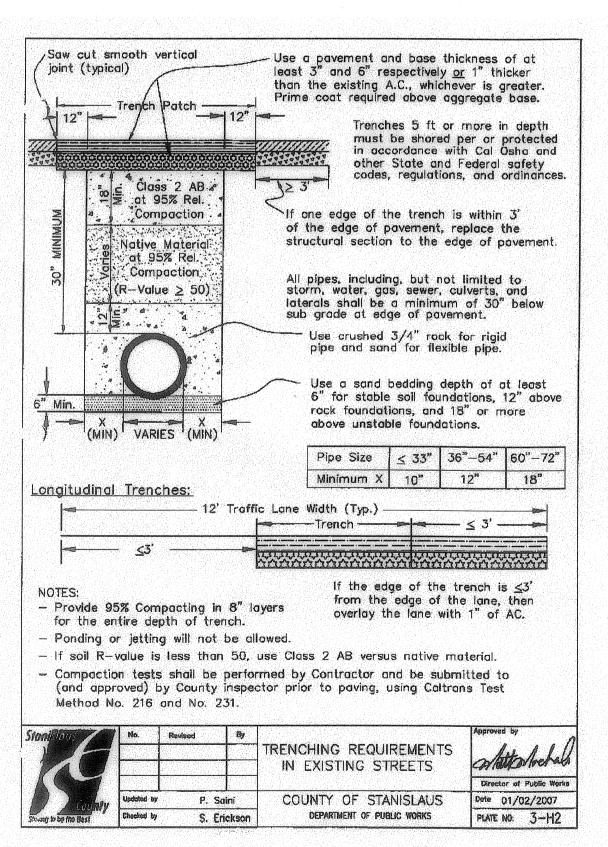

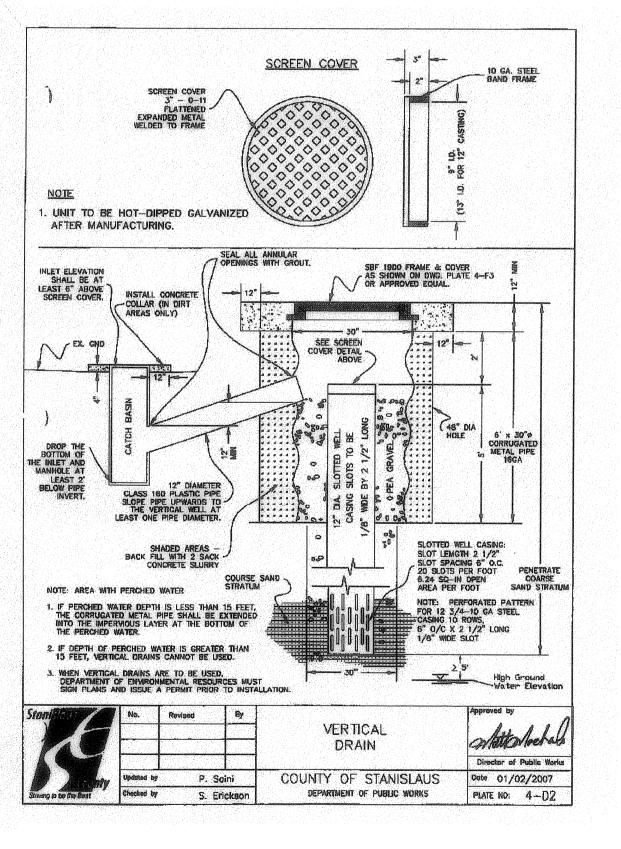

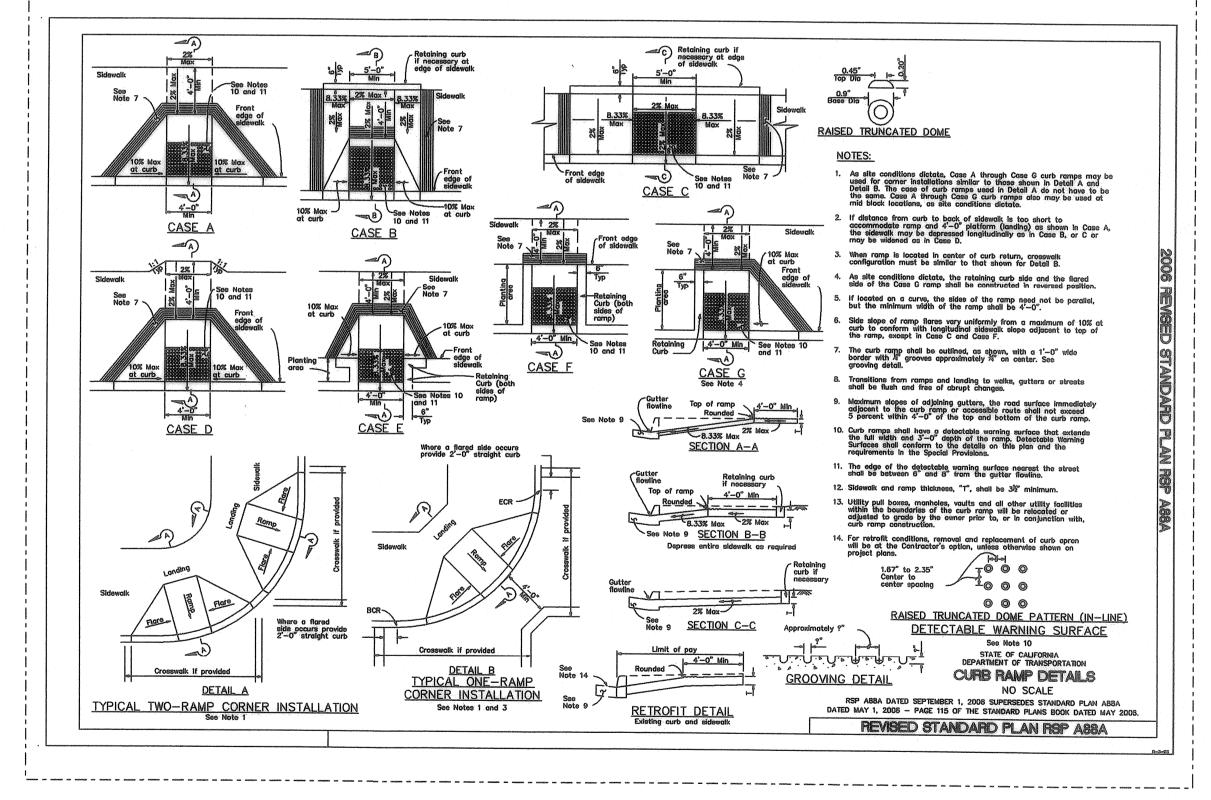

# STANISLAUS COUNTY CONSTRUCTION NOTES:


- 1. FORTY-EIGHT HOUR ADVANCED NOTICE SHALL BE PROVIDED TO ENCROACHMENT INSPECTOR PRIOR TO START OF CONSTRUCTION.
- 2. ALL MATERIAL AND WORK SHALL CONFORM TO STANISLAUS COUNTY SPECIFICATIONS AND IMPROVEMENT STANDARDS AND CALTRANS 2006 STANDARD SPECIFICATIONS. ALL IMPROVEMENTS ARE SUBJECT TO THE INSPECTION AND APPROVAL OF THE PUBLIC WORKS DEPARTMENT.
- 3. THE CONTRACTOR SHALL TAKE PRECAUTIONARY MEASURES TO PROTECT ALL UTILITIES.
  THE CONTRACTOR SHALL NOT ANY PERFORM EXCAVATION UNTIL ALL UTILITY AGENCIES AND THE
  STANISLAUS COUNTY DEPARTMENT OF PUBLIC WORKS HAVE BEEN NOTIFIED AND HAVE
  BEEN GIVEN THE OPPORTUNITY TO MARK THEIR FACILITIES IN THE FIELD. THE CONTRACTOR
  SHALL CALL U.S.A. AT LEAST FORTY-EIGHT (48) HOURS PRIOR TO DOING ANY EXCAVATING.
- 4. PRIOR TO INITIATING ANY CONSTRUCTION, THE CONTRACTOR SHALL VERIFY THAT ALL NECESSARY FEDERAL, STATE, AND LOCAL PERMITS AND/OR AUTHORIZATIONS HAVE BEEN OBTAINED.
- 5. THESE PLANS HAVE BEEN CHECKED BY THE STANISLAUS COUNTY DEPARTMENT OF PUBLIC WORKS AND/OR AUTHORIZED REPRESENTATIVE, BUT SUCH CHECKING AND/OR APPROVAL DOES NOT RELEIVE THE CONTRACTOR FROM HIS/HER RESPONSIBILITY TO CORRECT ERRORS, OMISSIONS, OR MAKE CHANGES REQUIRED BY CONDITIONS DISCOVERED IN THE FIELD DURING COURSE OF CONSTRUCTION.
- 6. THE CONTRACTOR SHALL CONTROL DUST AT ALL TIMES. DUST CONTROL SHALL BE THE RESPONSIBILITY OF THE CONTRACTOR AND SHALL BE IMPLEMENTED IN ACCORDANCE WITH APPLICABLE FEDERAL, STATE, AND LOCAL GUIDELINES (INCLUDING, BUT NOT LIMITED TO THE SAN JOAQUIN VALLEY AIR POLLUTION CONTROL DISTRICT).
- 7. CONSTRUCTION STAKING FOR CURB, GUTTER, AND SIDEWALK, SANITARY SEWERS, STORM DRAINS, WATER LINES, FIRE HYDRANT, ELECTROLIERS, ETC. SHALL BE DONE UNDER THE DIRECTION OF A REGISTERED CIVIL ENGINEER OR LICENSED LAND SURVEYOR.
- 8. ALL UTILITY LINES ABANDONED DURING CONSTRUCTION SHALL BE REMOVED.

- 9. STREET STRIPING SHALL INCLUDE STOP BARS, CENTERLINE STRIPING, AND LANE LINE MARKERS, CROSSWALKS AND ALL OTHER MARKINGS REQUIRED BY THE ENGINEER.
  STRIPING SHALL BE DONE WITH THERMOPLASTIC AND REFLECTIVE MARKERS
- 10. ALL TRENCHES SHALL BE BACK FILLED IN ACCORDANCE WITH STANISLAUS COUNTY SPECIFICATIONS AND IMPROVEMENTS STANDARDS.
- 11. WHEN WIDENING THE PAVEMENT ON AN EXISTING ROAD, THE EXISTING PAVEMENT SHALL BE SAWCUT TO A NEAT LINE AND REMOVED BACK TO AN EXISTING ADEQUATE STRUCTURAL SECTION, OR TO THE ORIGINAL ROAD SECTION. AN EXPLORATORY TRENCH, OR POT-HOLING, MAY BE REQUIRED TO DETERMINE THE LIMITS OF PAVEMENT REMOVAL
- 12. EXISTING CURB AND SIDEWALK WITHIN THE PROJECT LIMITS THAT ARE DAMAGED OR DISPLACED EVEN THOUGH THEY WERE NOT TO BE REMOVED, SHALL BE REPAIRED OR REPLACED PER STANISLAUS COUNTY STANDARDS EVEN IF DAMAGE OR DISPLACEMENT OCCURRED PRIOR TO ANY WORK PERFORMED BY THE CONTRACTOR.
- 13. MANHOLES, VALVES, CLEAN OUTS, ETC. SHALL BE BROUGHT TO FINISH GRADE BY THE CONTRACTOR AFTER THE FINAL PAVING COURSE IS PLACED.
- 14. ALL CONSTRUCTION SITE ACTIVITIES SHALL CONFORM TO THE STATE WATER RESOURCES CONTROL BOARD, NATIONAL POLLUTION DISCHARGE ELIMINATION SYSTEM (NPDES), WASTE DISCHARGE REQUIREMENTS FOR DISCHARGES OF STORM WATER RUNOFF ASSOCIATED WITH CONSTRUCTION ACTIVITY.

RCE No. 53311

(EXP. 06-30-11)

15. ALL CONSTRUCTION SITE ACTIVITIES SHALL COMPLY WITH ALL CONDITIONS OF APPROVAL, DEVELOPMENT STANDARDS, AND/OR MITIGATION MEASURES ADOPTED BY THE PLANNING COMMISSION AND/OR BOARD OF SUPERVISORS FOR THE SPECIFIC PROJECT.

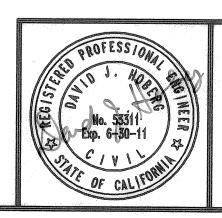



Y ROAD SUITE J MODESTO, CA. 95350
JE (209) 529-7450

Aug. 27, 2010

of 9 sheet

0905

DJH

1"=30'

SHEET

NUMBER

JUL, 2009

JOB NO\_\_


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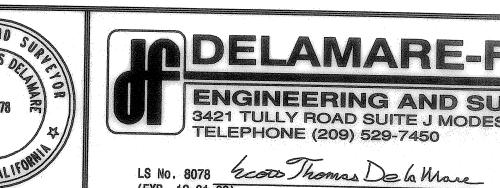
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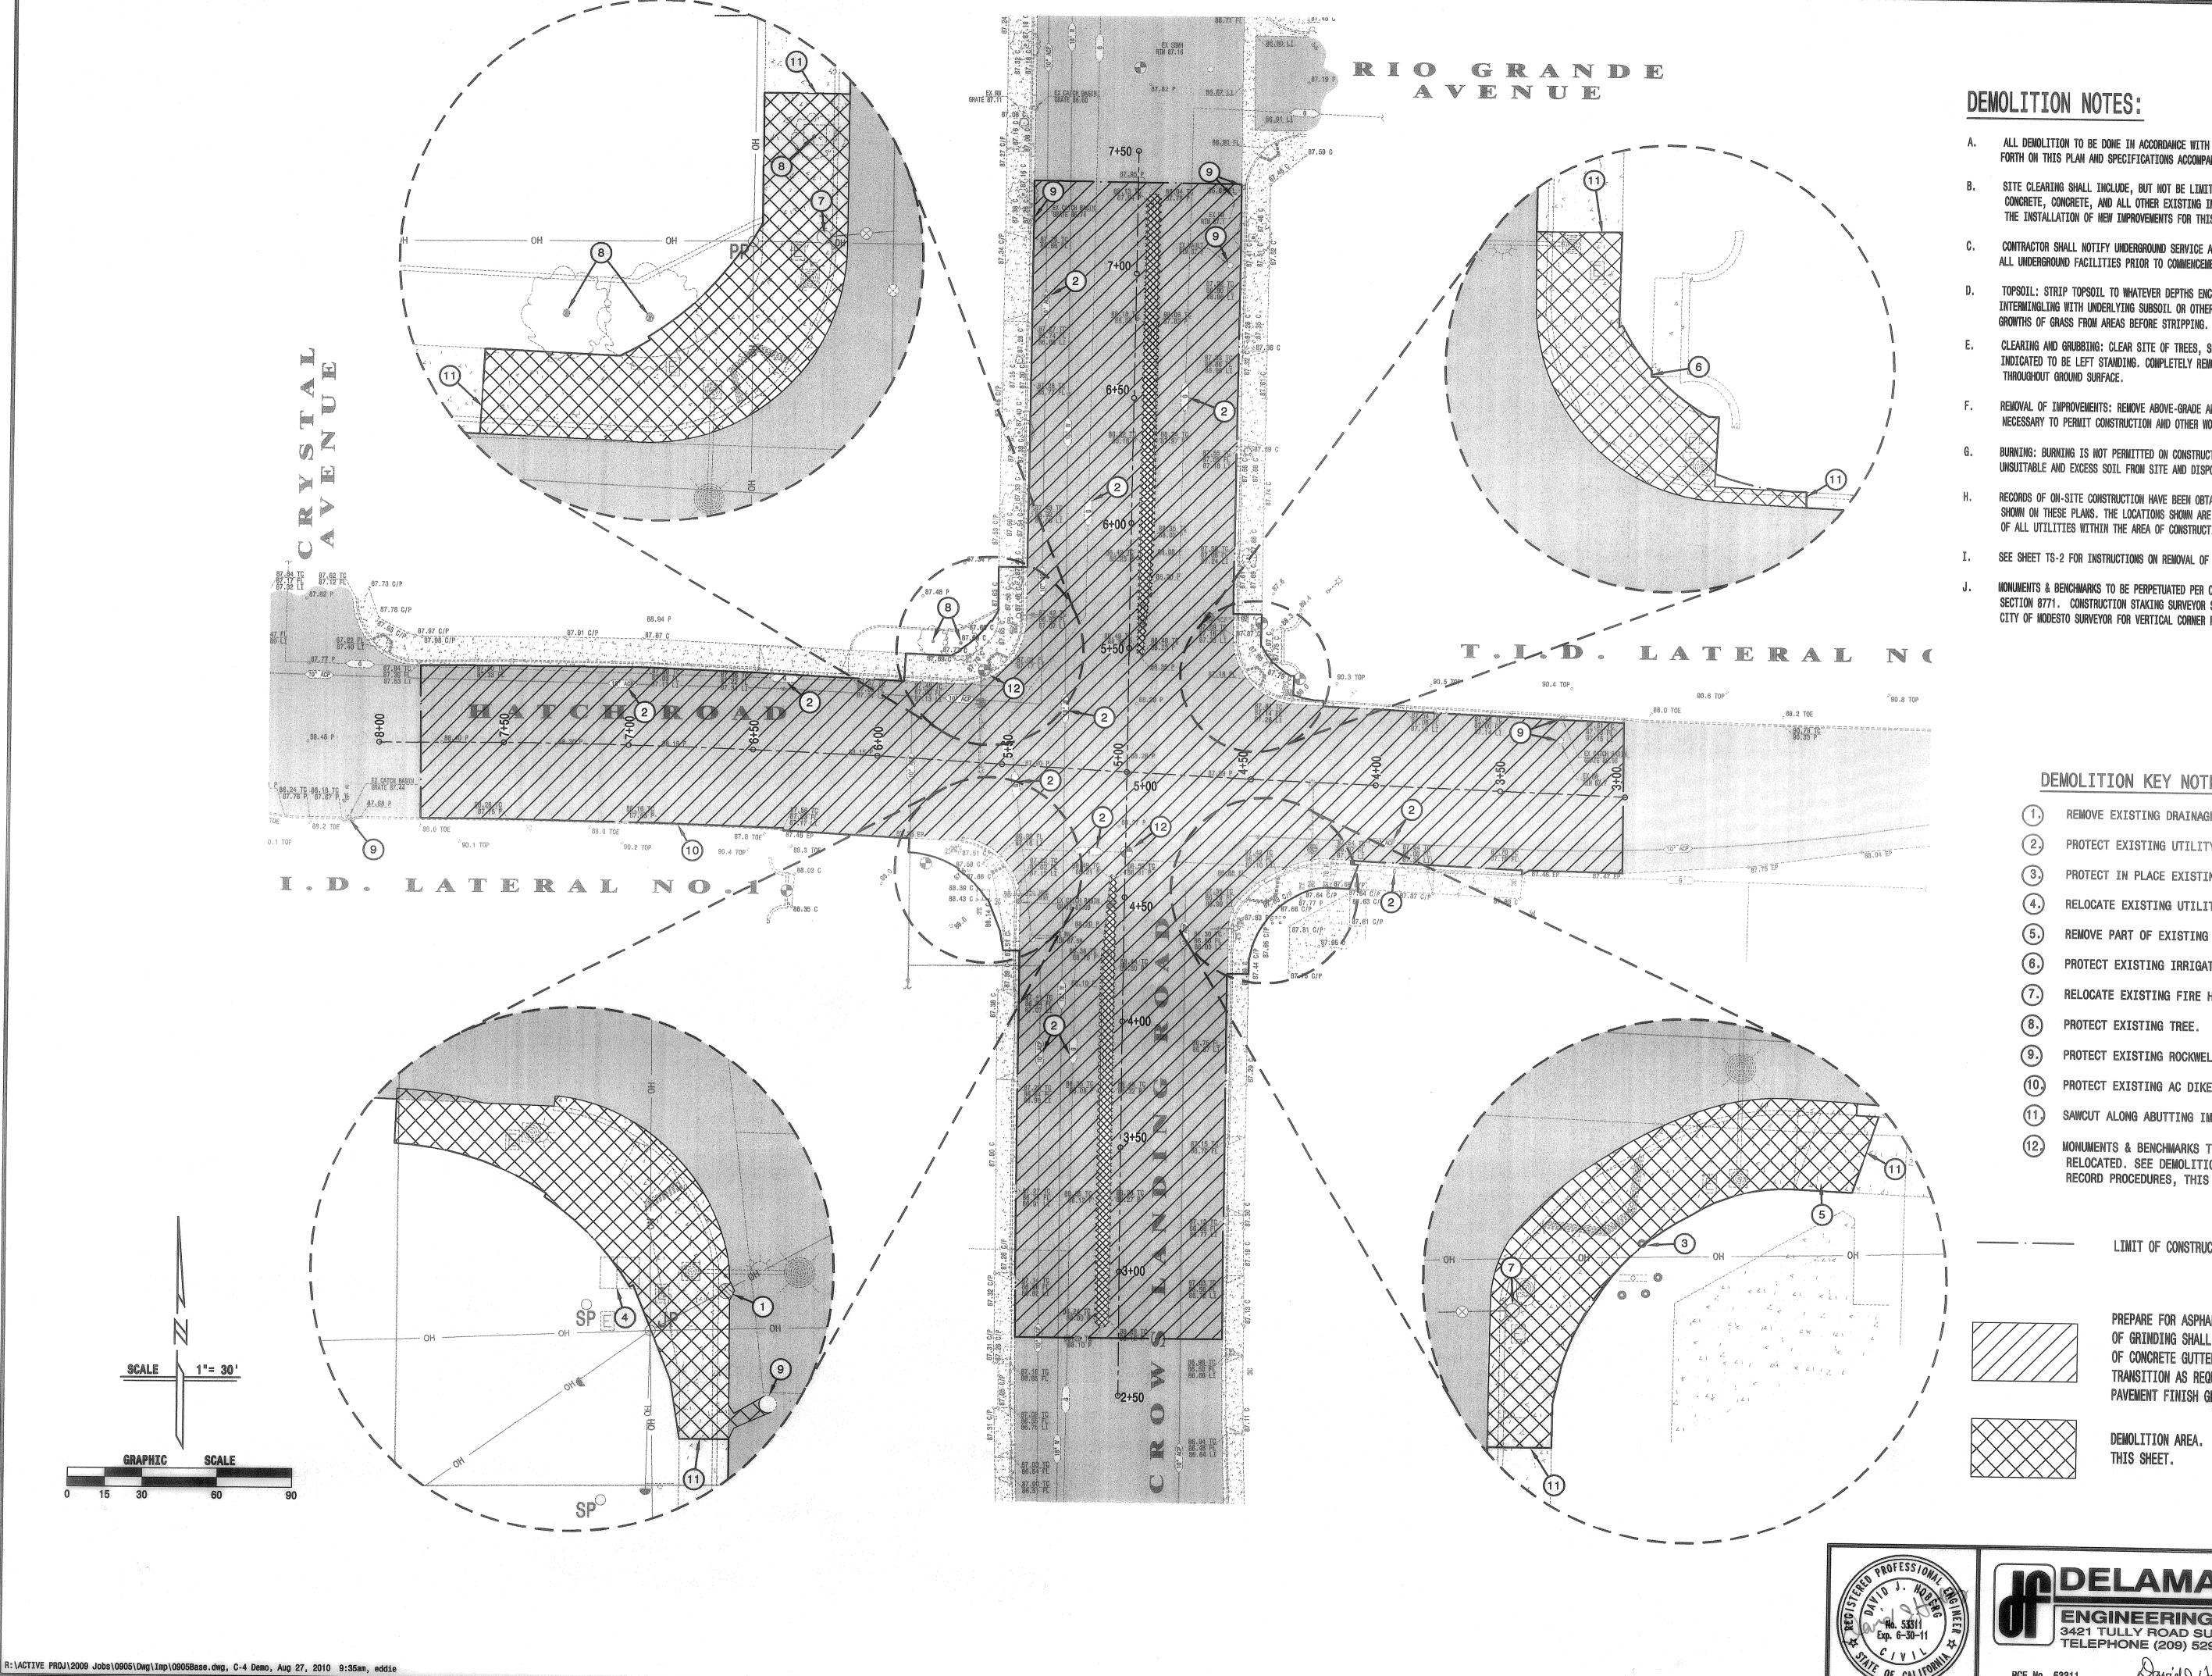




(EXP. 12-31-09)

of 9

SHEETS

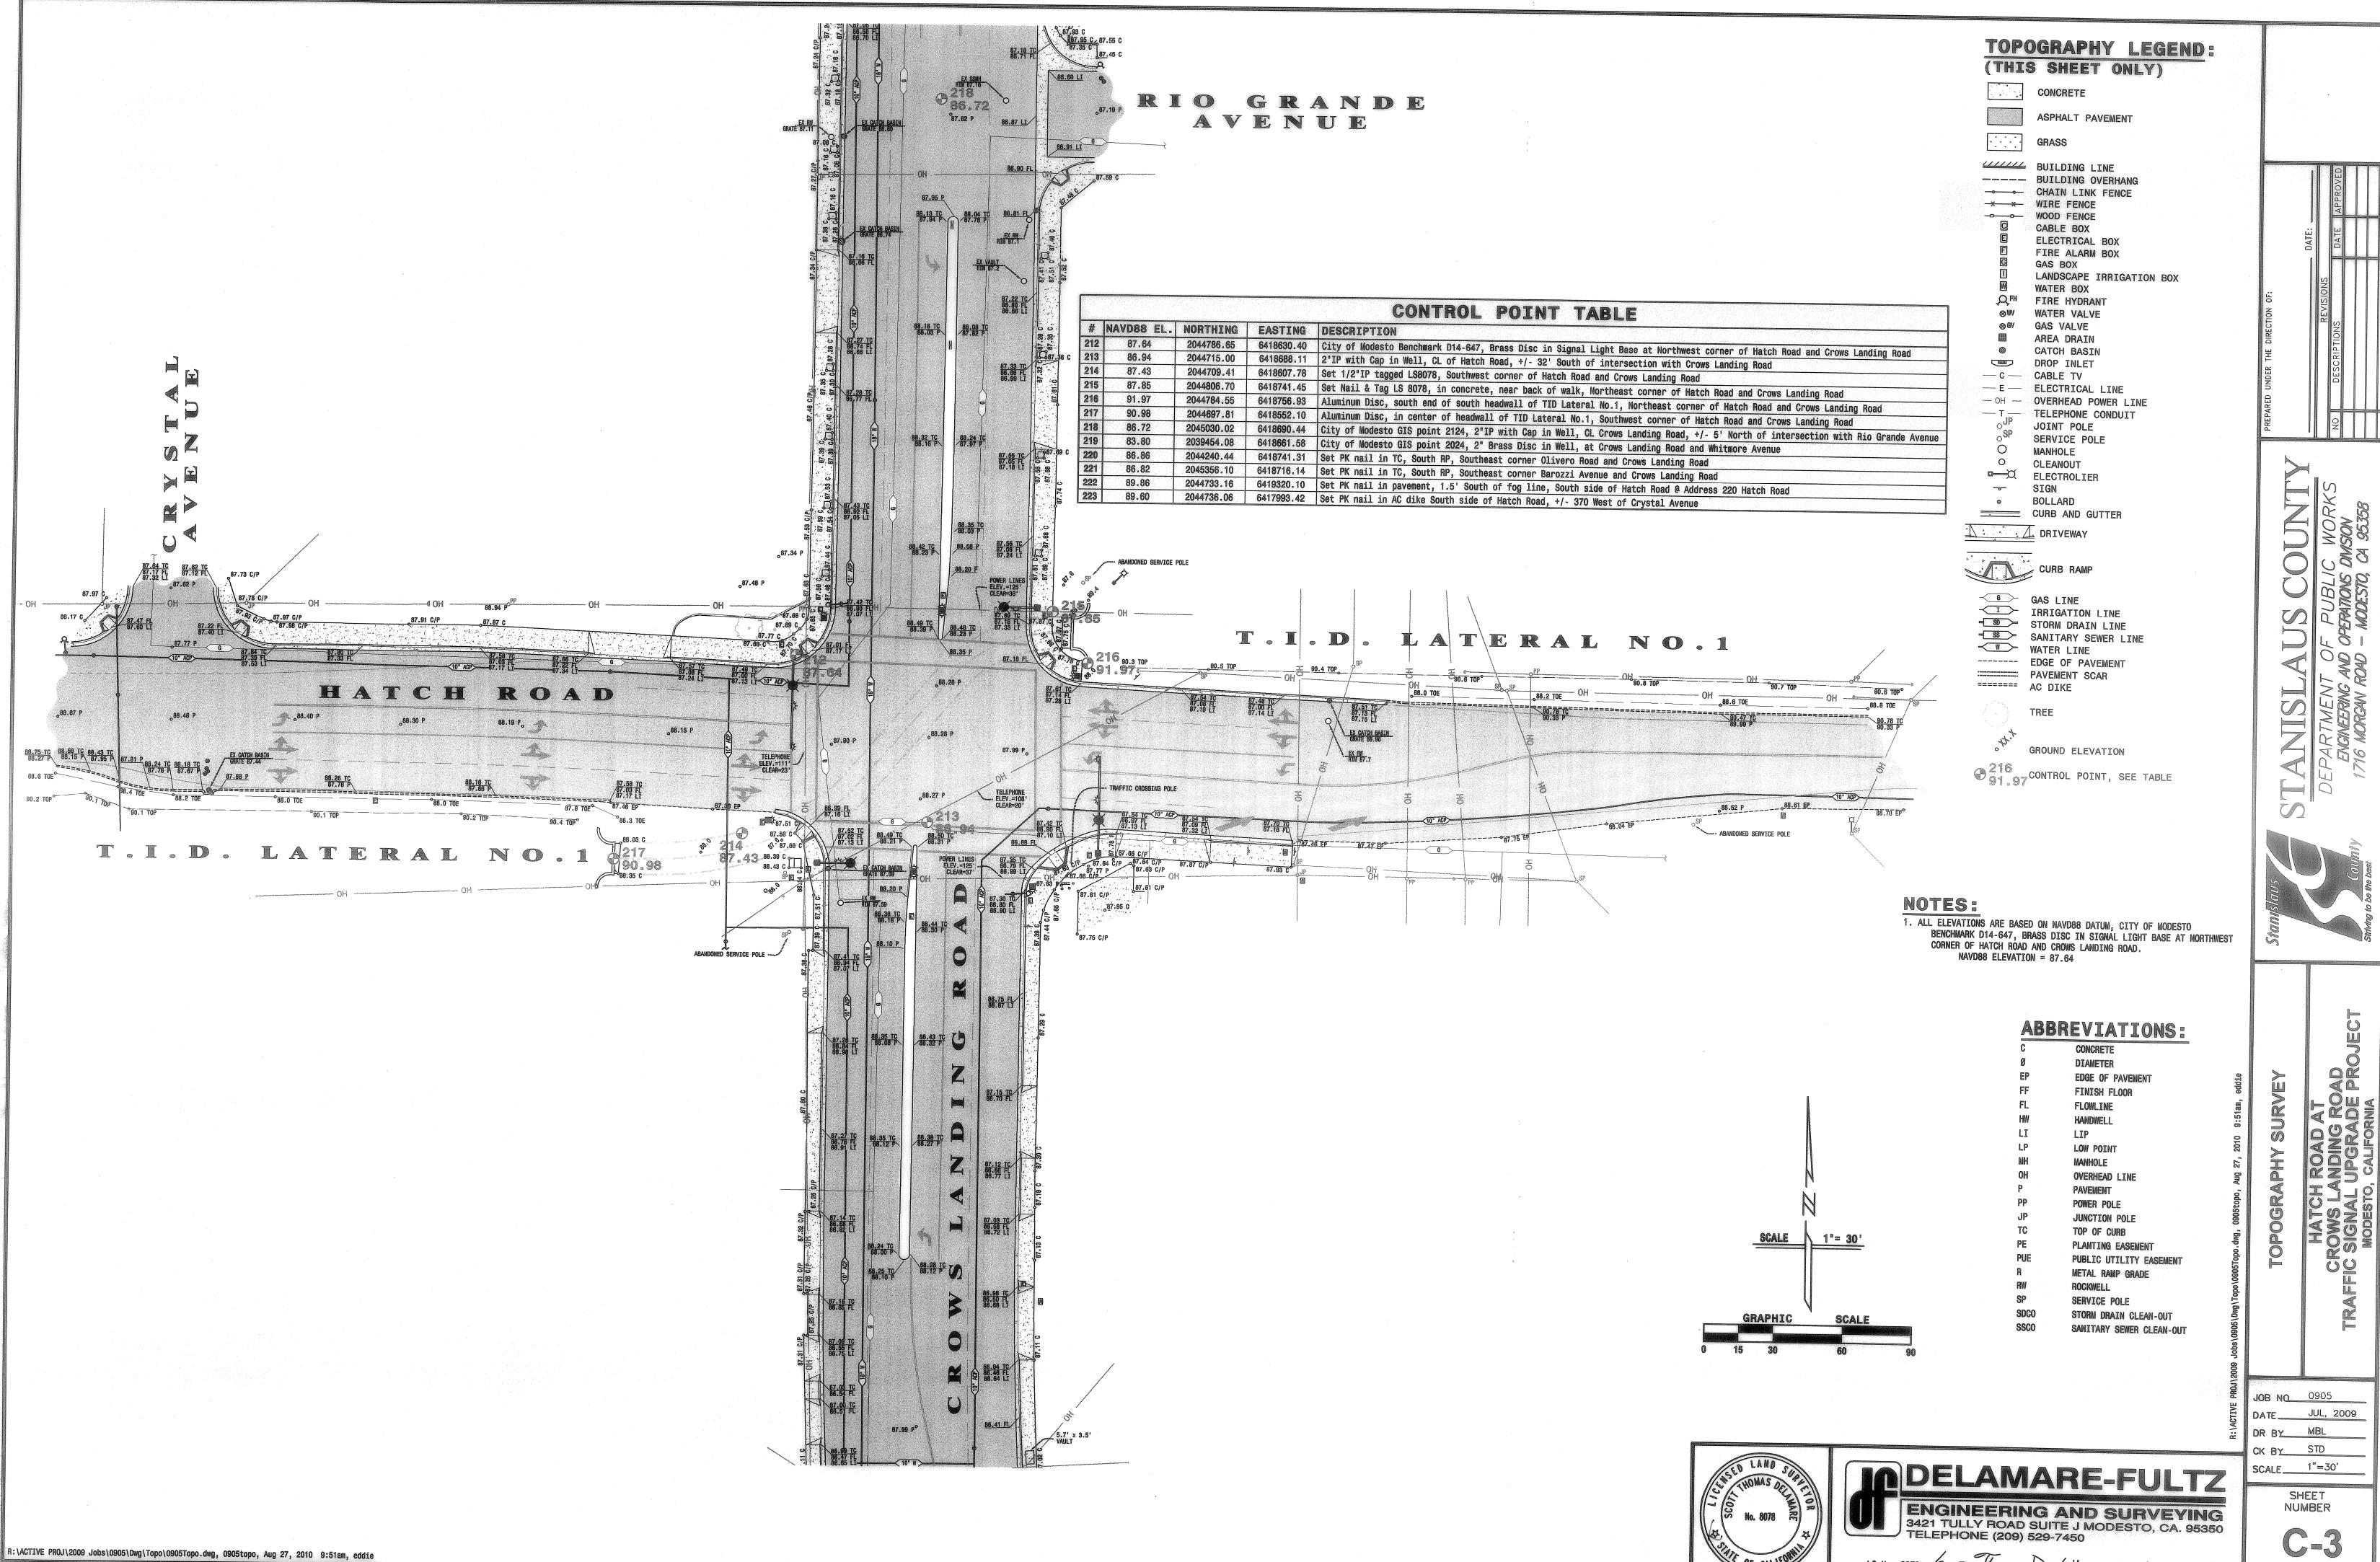

- A. ALL DEMOLITION TO BE DONE IN ACCORDANCE WITH THE RECOMMENDATIONS SET FORTH ON THIS PLAN AND SPECIFICATIONS ACCOMPANYING THIS PROJECT.
- SITE CLEARING SHALL INCLUDE, BUT NOT BE LIMITED TO, THE REMOVAL OF STRIPING, ASPHALT CONCRETE, CONCRETE, AND ALL OTHER EXISTING IMPROVEMENTS OR OBSTRUCTIONS INTERFERING WITH THE INSTALLATION OF NEW IMPROVEMENTS FOR THIS PROJECT.
- CONTRACTOR SHALL NOTIFY UNDERGROUND SERVICE ALERT (800) 227-2600 FOR VERIFICATION OF ALL UNDERGROUND FACILITIES PRIOR TO COMMENCEMENT OF DEMOLITION ACTIVITIES.
- TOPSOIL: STRIP TOPSOIL TO WHATEVER DEPTHS ENCOUNTERED IN A MANNER TO PREVENT INTERMINGLING WITH UNDERLYING SUBSOIL OR OTHER OBJECTION MATERIAL. REMOVE HEAVY
- E. CLEARING AND GRUBBING: CLEAR SITE OF TREES, SHRUBS AND OTHER VEGETATION, EXCEPT FOR THOSE INDICATED TO BE LEFT STANDING. COMPLETELY REMOVE STUMPS, ROOTS, AND OTHER DEBRIS PROTRUDING THROUGHOUT GROUND SURFACE.
- F. REMOVAL OF IMPROVEMENTS: REMOVE ABOVE-GRADE AND BELOW-GRADE IMPROVEMENTS AS NECESSARY TO PERMIT CONSTRUCTION AND OTHER WORK AS INDICATED.
- G. BURNING: BURNING IS NOT PERMITTED ON CONSTRUCTION SITE. REMOVE ALL WASTE MATERIALS AND UNSUITABLE AND EXCESS SOIL FROM SITE AND DISPOSE OF PROPERTY.
- H. RECORDS OF ON-SITE CONSTRUCTION HAVE BEEN OBTAINED AND THE RESULTS OF THESE SEARCHES ARE SHOWN ON THESE PLANS. THE LOCATIONS SHOWN ARE NOT GUARANTEED FOR ACCURACY, NOR TOTALITY OF ALL UTILITIES WITHIN THE AREA OF CONSTRUCTION.
- SEE SHEET TS-2 FOR INSTRUCTIONS ON REMOVAL OF EXISTING TRAFFIC SIGNAL AND LIGHTING WORK.
- MONUMENTS & BENCHMARKS TO BE PERPETUATED PER CALIFORNIA BUSINESS AND PROFESSION CODE SECTION 8771. CONSTRUCTION STAKING SURVEYOR SHALL CONTACT STANISLAUS COUNTY SURVEYOR AND CITY OF MODESTO SURVEYOR FOR VERTICAL CORNER RECORD PROCEDURES TO COMPLY WITH SECTION 8771.

# DEMOLITION KEY NOTES

- REMOVE EXISTING DRAINAGE INLET AND PLUG PIPE.
- PROTECT EXISTING UTILITY AND RELATED STRUCTURES.
- (3) PROTECT IN PLACE EXISTING TRAFFIC CROSSING POLE.
- RELOCATE EXISTING UTILITY CABINET (SEE TS-1).
- REMOVE PART OF EXISTING DRIVEWAY.
- PROTECT EXISTING IRRIGATION STRUCTURE.
- RELOCATE EXISTING FIRE HYDRANT.
- PROTECT EXISTING TREE.
- PROTECT EXISTING ROCKWELL AND/OR DRAINAGE INLET.
- PROTECT EXISTING AC DIKE.
- SAWCUT ALONG ABUTTING IMPROVEMENTS.
- MONUMENTS & BENCHMARKS TO BE PROTECTED-N-PLACE AND/OR RELOCATED. SEE DEMOLITION NOTES, NOTE J FOR CORNER RECORD PROCEDURES, THIS SHEET.

LIMIT OF CONSTRUCTION

PREPARE FOR ASPHALT CONCRETE OVERLAY. DEPTH OF GRINDING SHALL BE 0.25' AT EXISTING EDGE OF CONCRETE GUTTERS. DEPTH OF GRINDING SHALL TRANSITION AS REQUIRED TO ACHIEVE THE PAVEMENT FINISH GRADES SHOWN ON SHEET C-7.

DEMOLITION AREA. SEE DEMOLITION NOTES ON THIS SHEET.



RCE No. 53311

(EXP. 06-30-17)

David J. Hobers


Aug. 27, 2010


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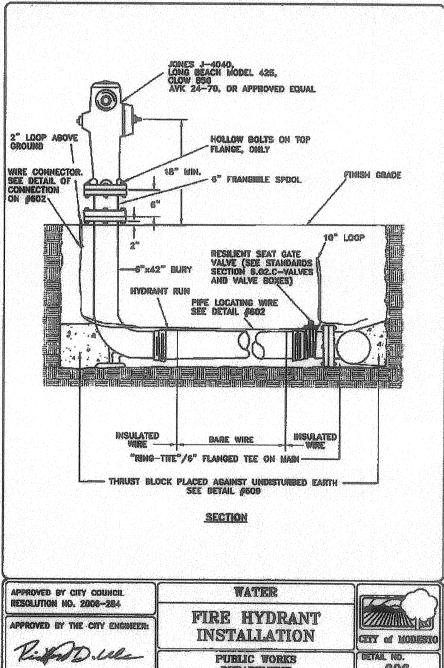
JOB NO 0905 DATE\_\_\_\_JUL, 2009 DR BY SF CK BY DJH SCALE\_\_\_\_1"=30'

> SHEET NUMBER



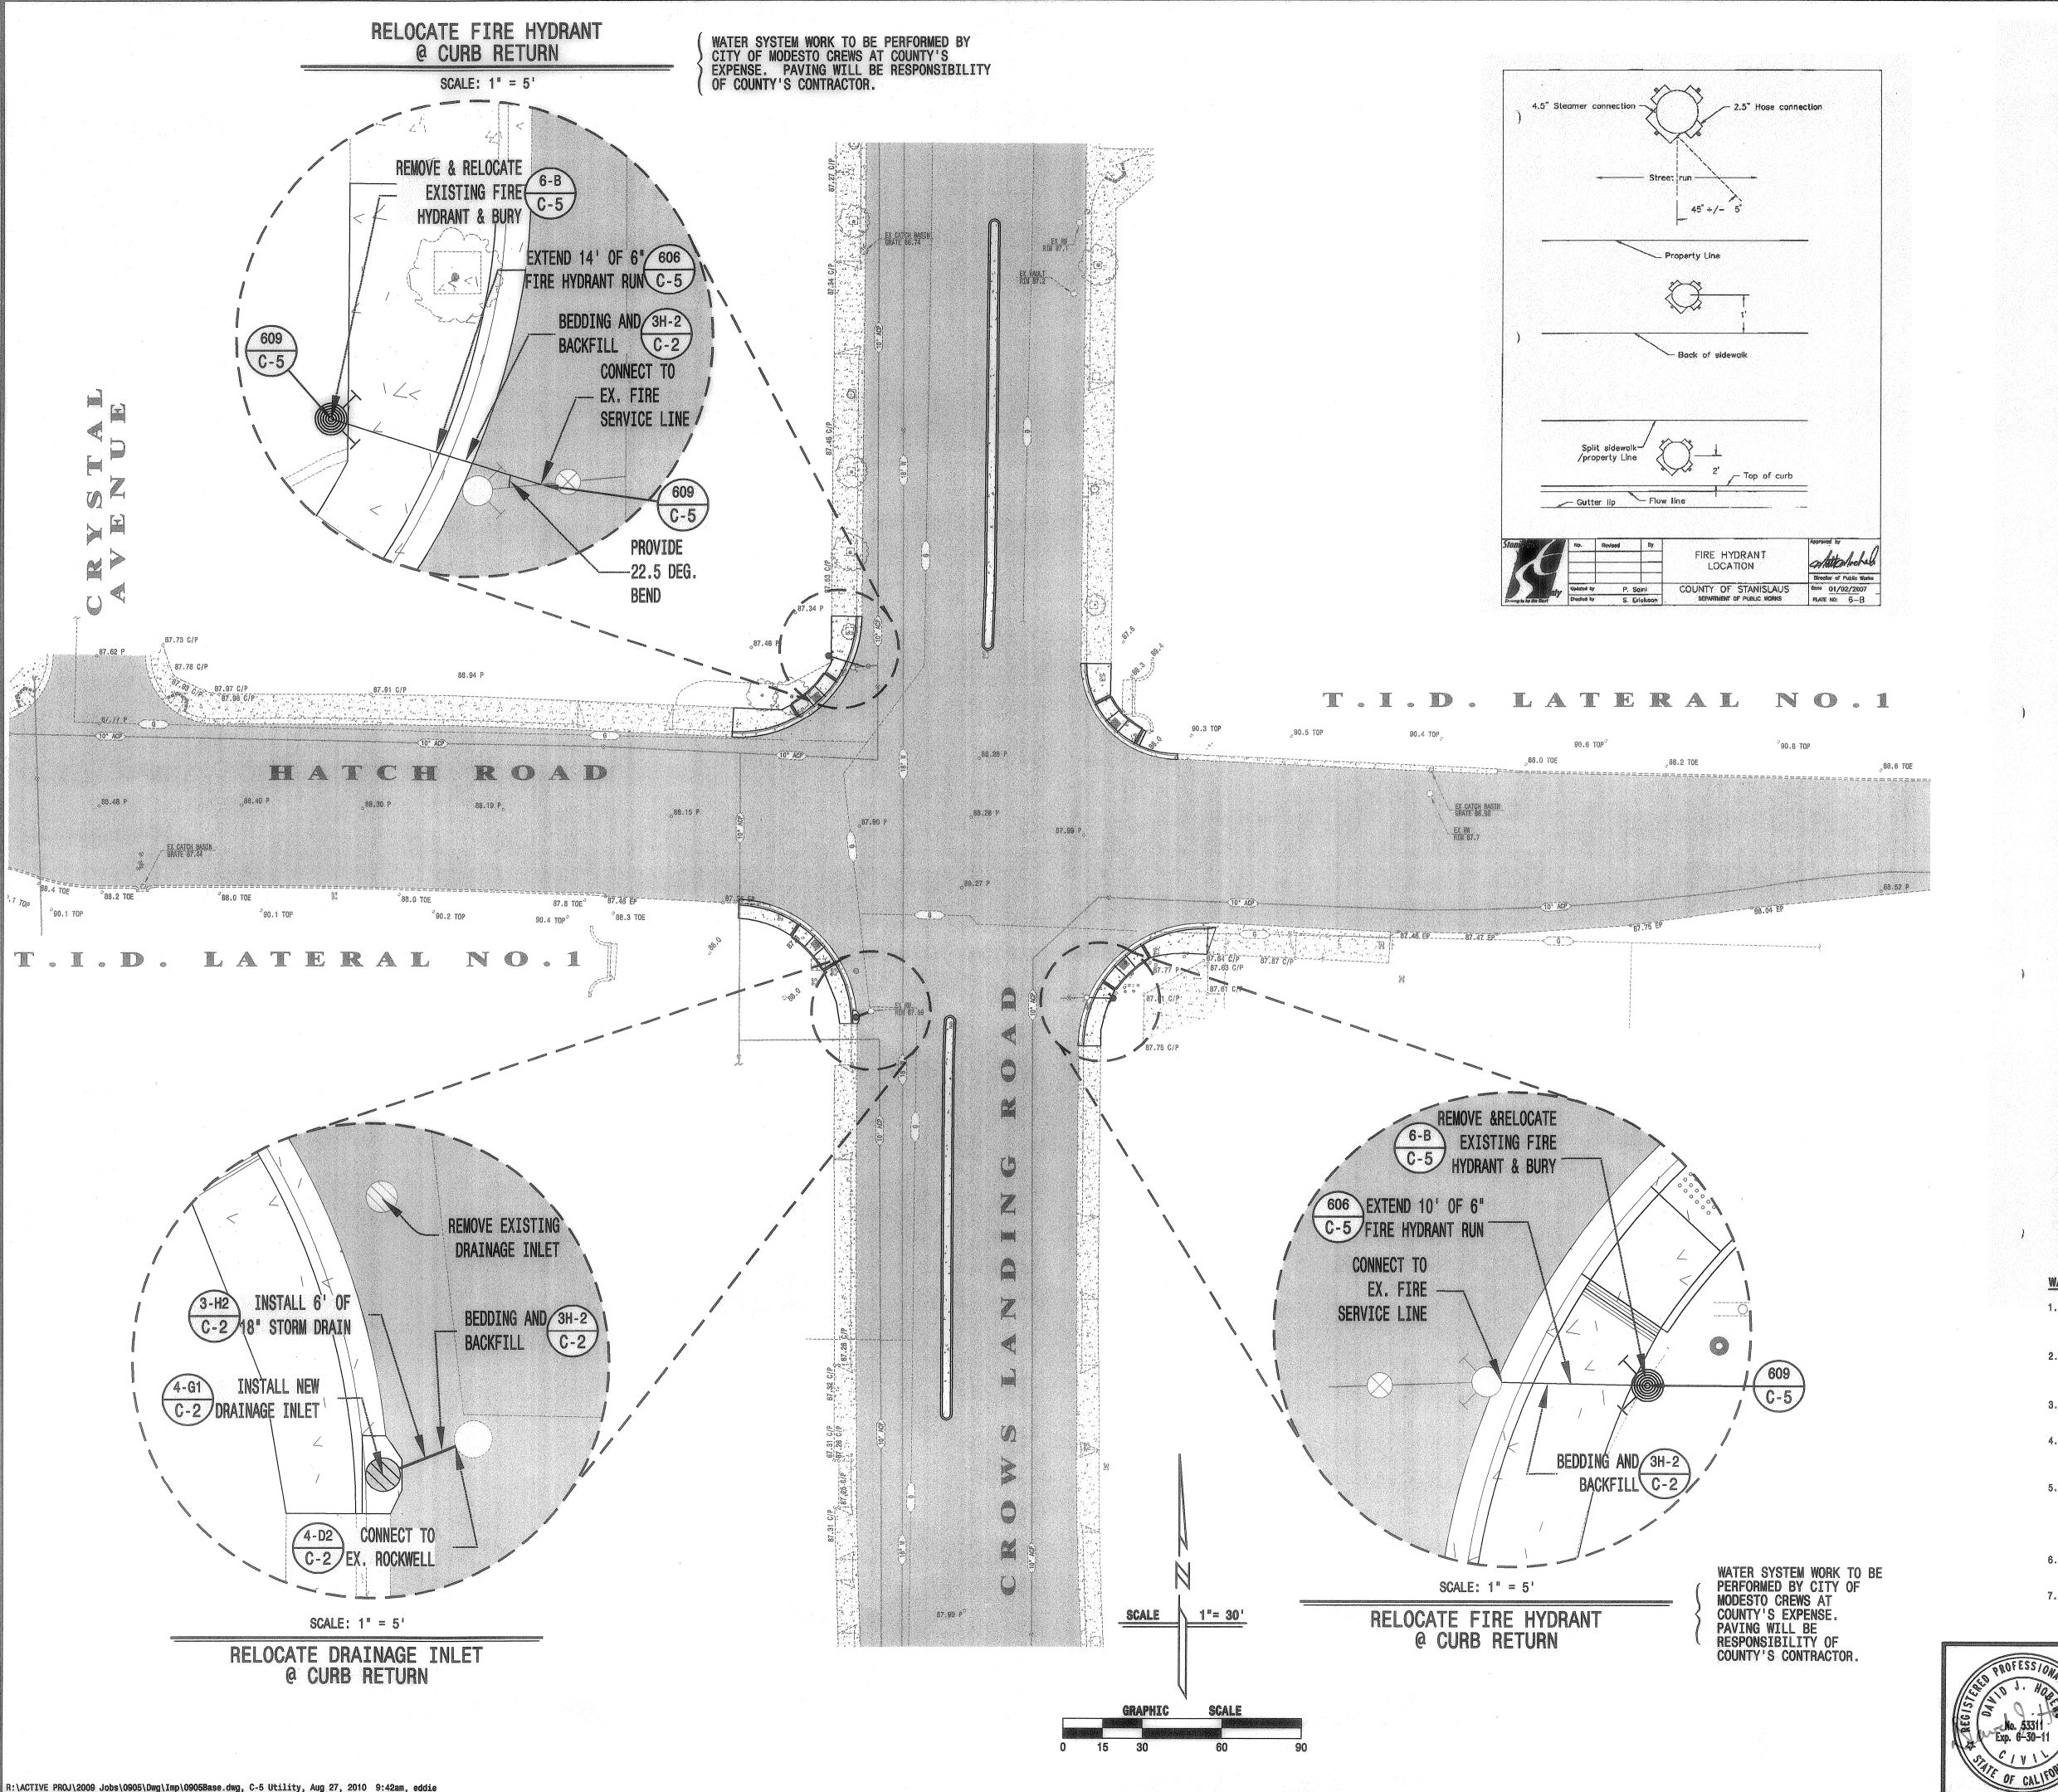


APPROVED BY CITY COUNCIL RESOLUTION NO. 2008—284	WATER	
APPROVED BY THE CITY ENGINEER:	THRUST BLOCKING	CILL OF HODESL
	PUBLIC WORKS DEPARTMENT	DETAIL NO.

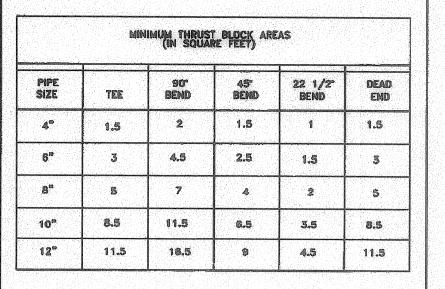

# WATER (PER CHAPTER 2 OF THE CITY OF MODESTO STANDARDS):

- 3. ALL VALVES, TEES, AND CROSSES TO BE FLANGED TO THEIR RESPECTIVE FITTINGS. WATER VALVES
- WATER MAINS AT THE END OF FUTURE STREETS SHALL HAVE TWO HALF-LENGTHS OF PIPE BETWEEN GATE VALVE AND BLOW-OFF. DEFLECTION OF WATER LINES SHALL NOT EXCEED 80% OF
- LATEST AWWA SPECIFICATIONS, C-503, FOR WET-BARREL FIRE HYDRANTS. ALL HYDRANTS SHALL BE PAINTED WITH CATERPILLAR YELLOW POLYURETHANE HIGH DUTY INDUSTRIAL ENAMEL. NO LEAD
- 6. ALL VALVE STEMS MUST BE BROUGHT TO A MINIMUM OF FOUR FEET (4') BELOW FINISHED GRADE WITH
- THRUST BLOCKS SHALL BE PROVIDED AT ALL REQUIRED LOCATIONS ON WATER LINES IN ACCORDANCE WITH THE CITY OF MODESTO SPECIFICATIONS AND DETAILS.

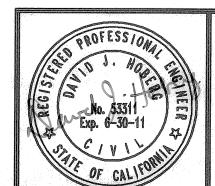




David J. Hobers RCE No. 53311 (EXP. 06-30-11)

Aug. 27, 2010

**√ JOB NO** 0905 DATE JUL, 2009

CK BY DJH SCALE 1"=30'

> SHEET NUMBER

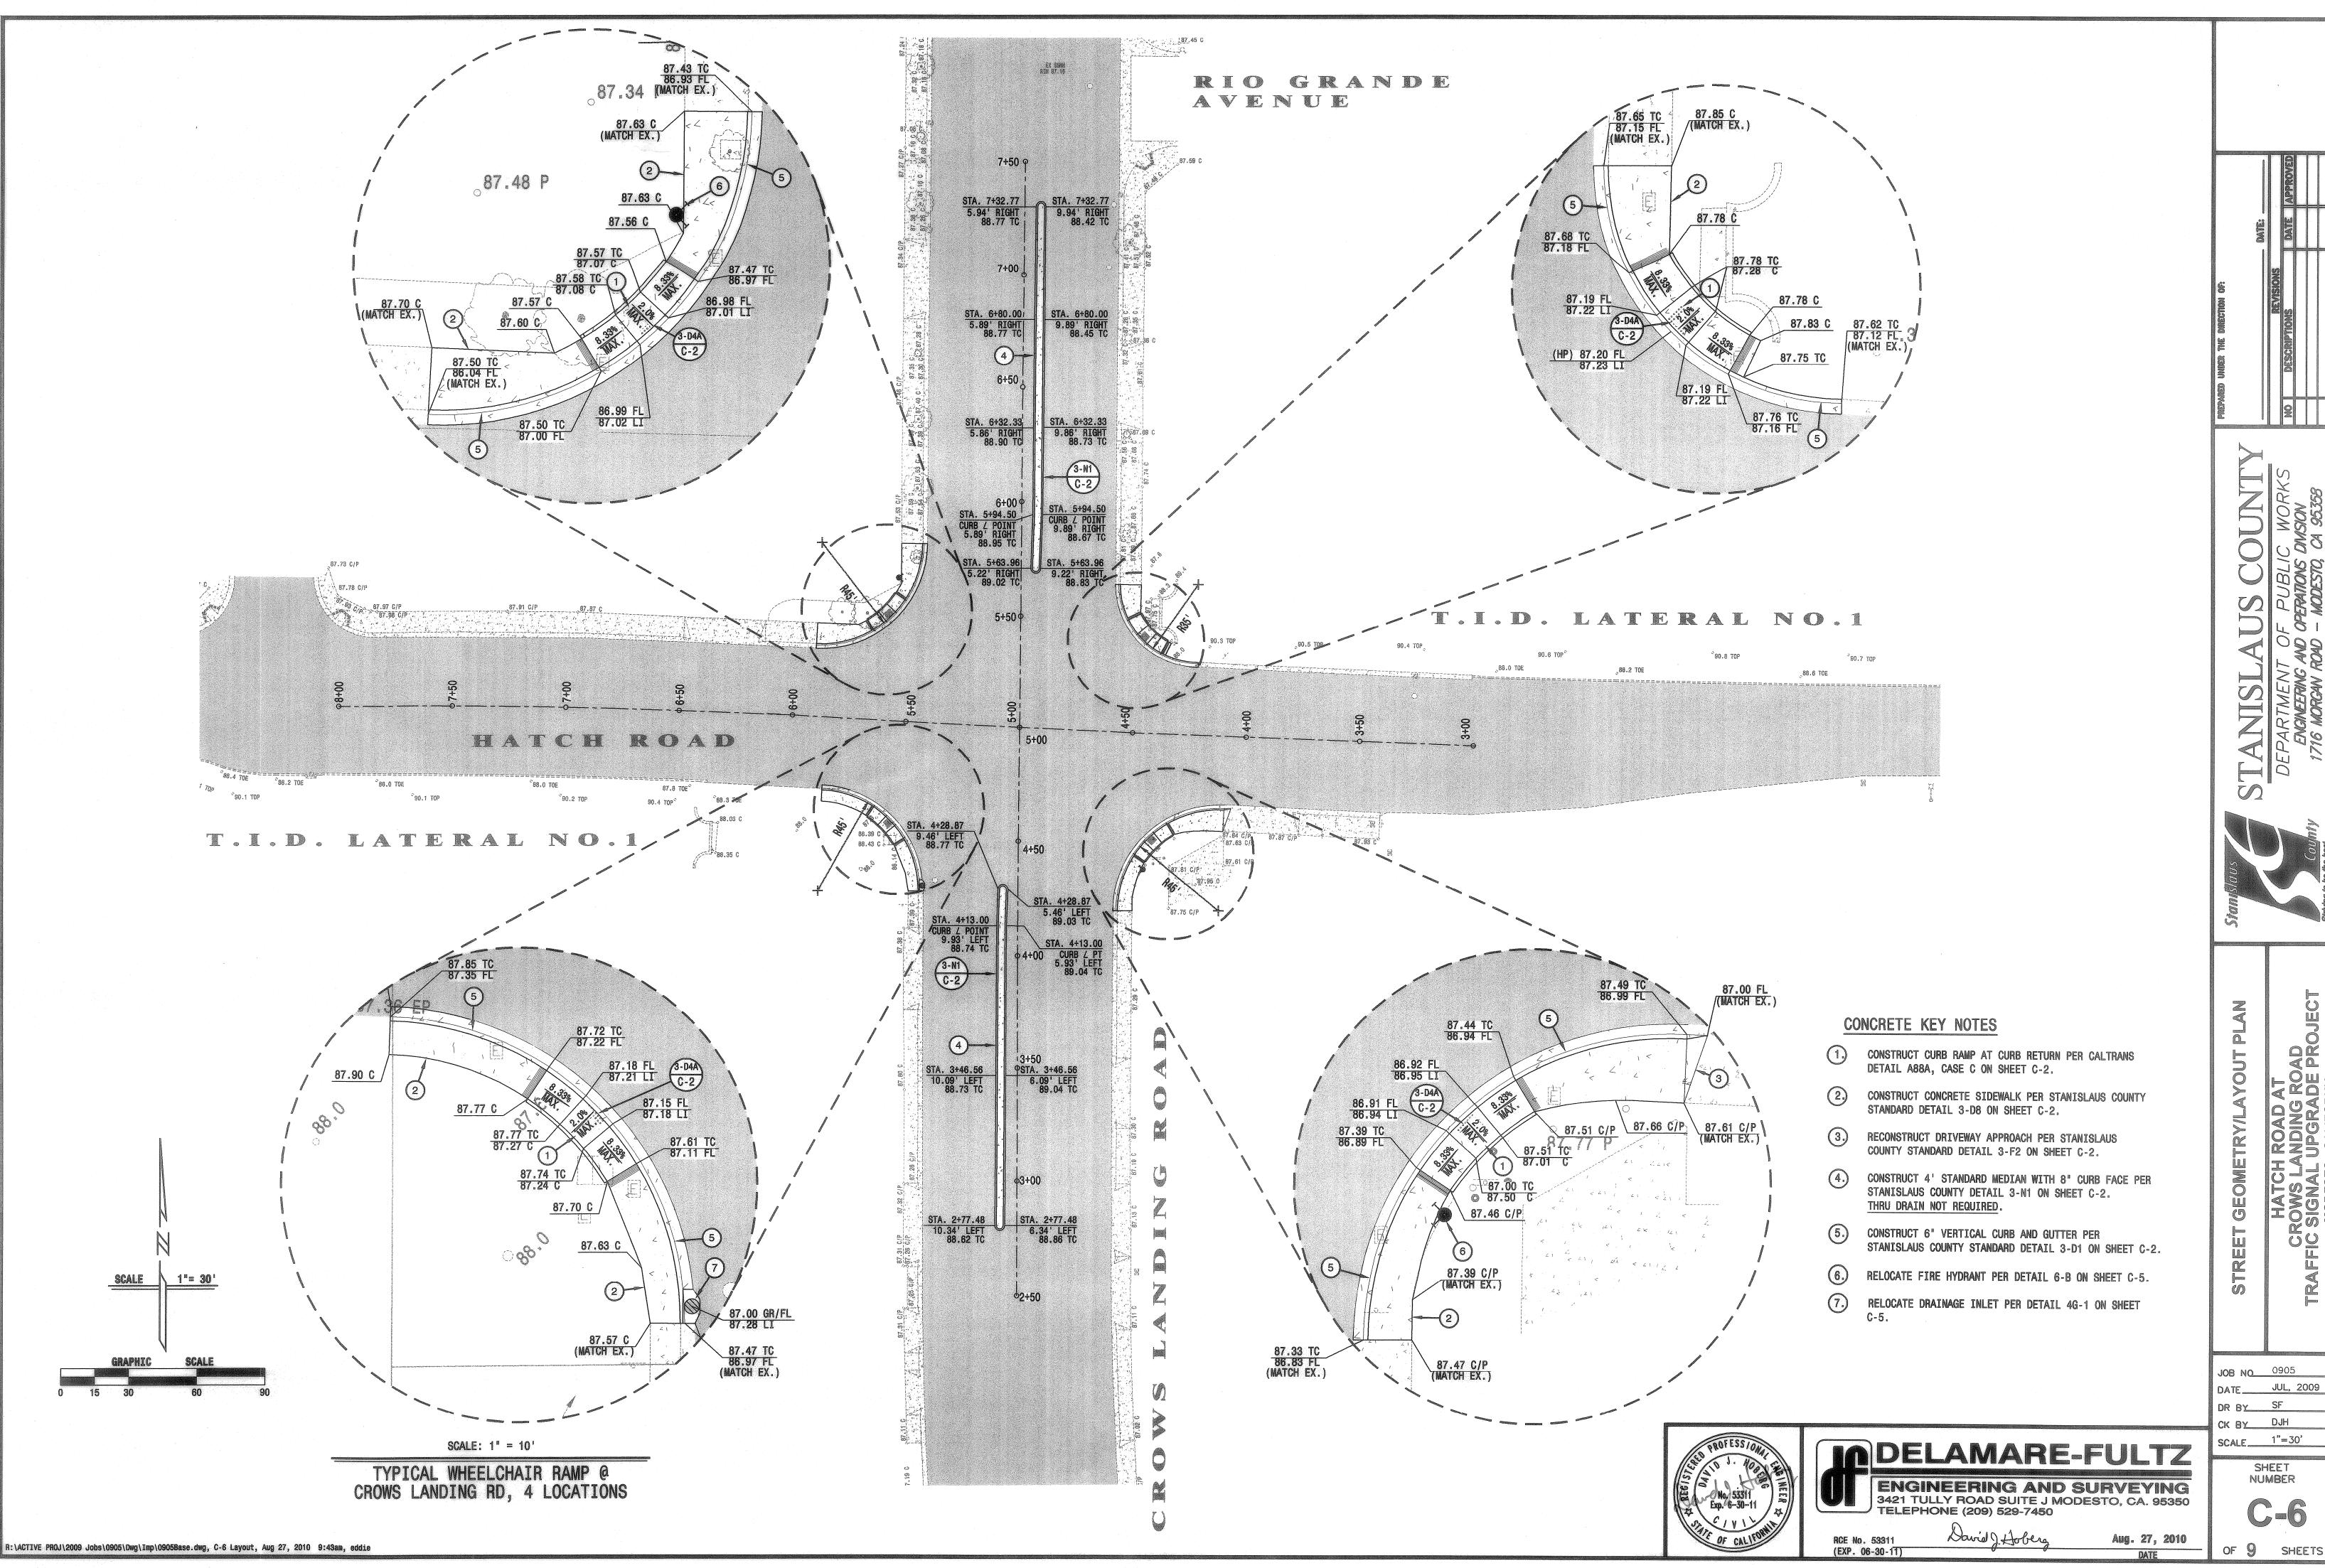





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of 9 Sheets





# NOTES:

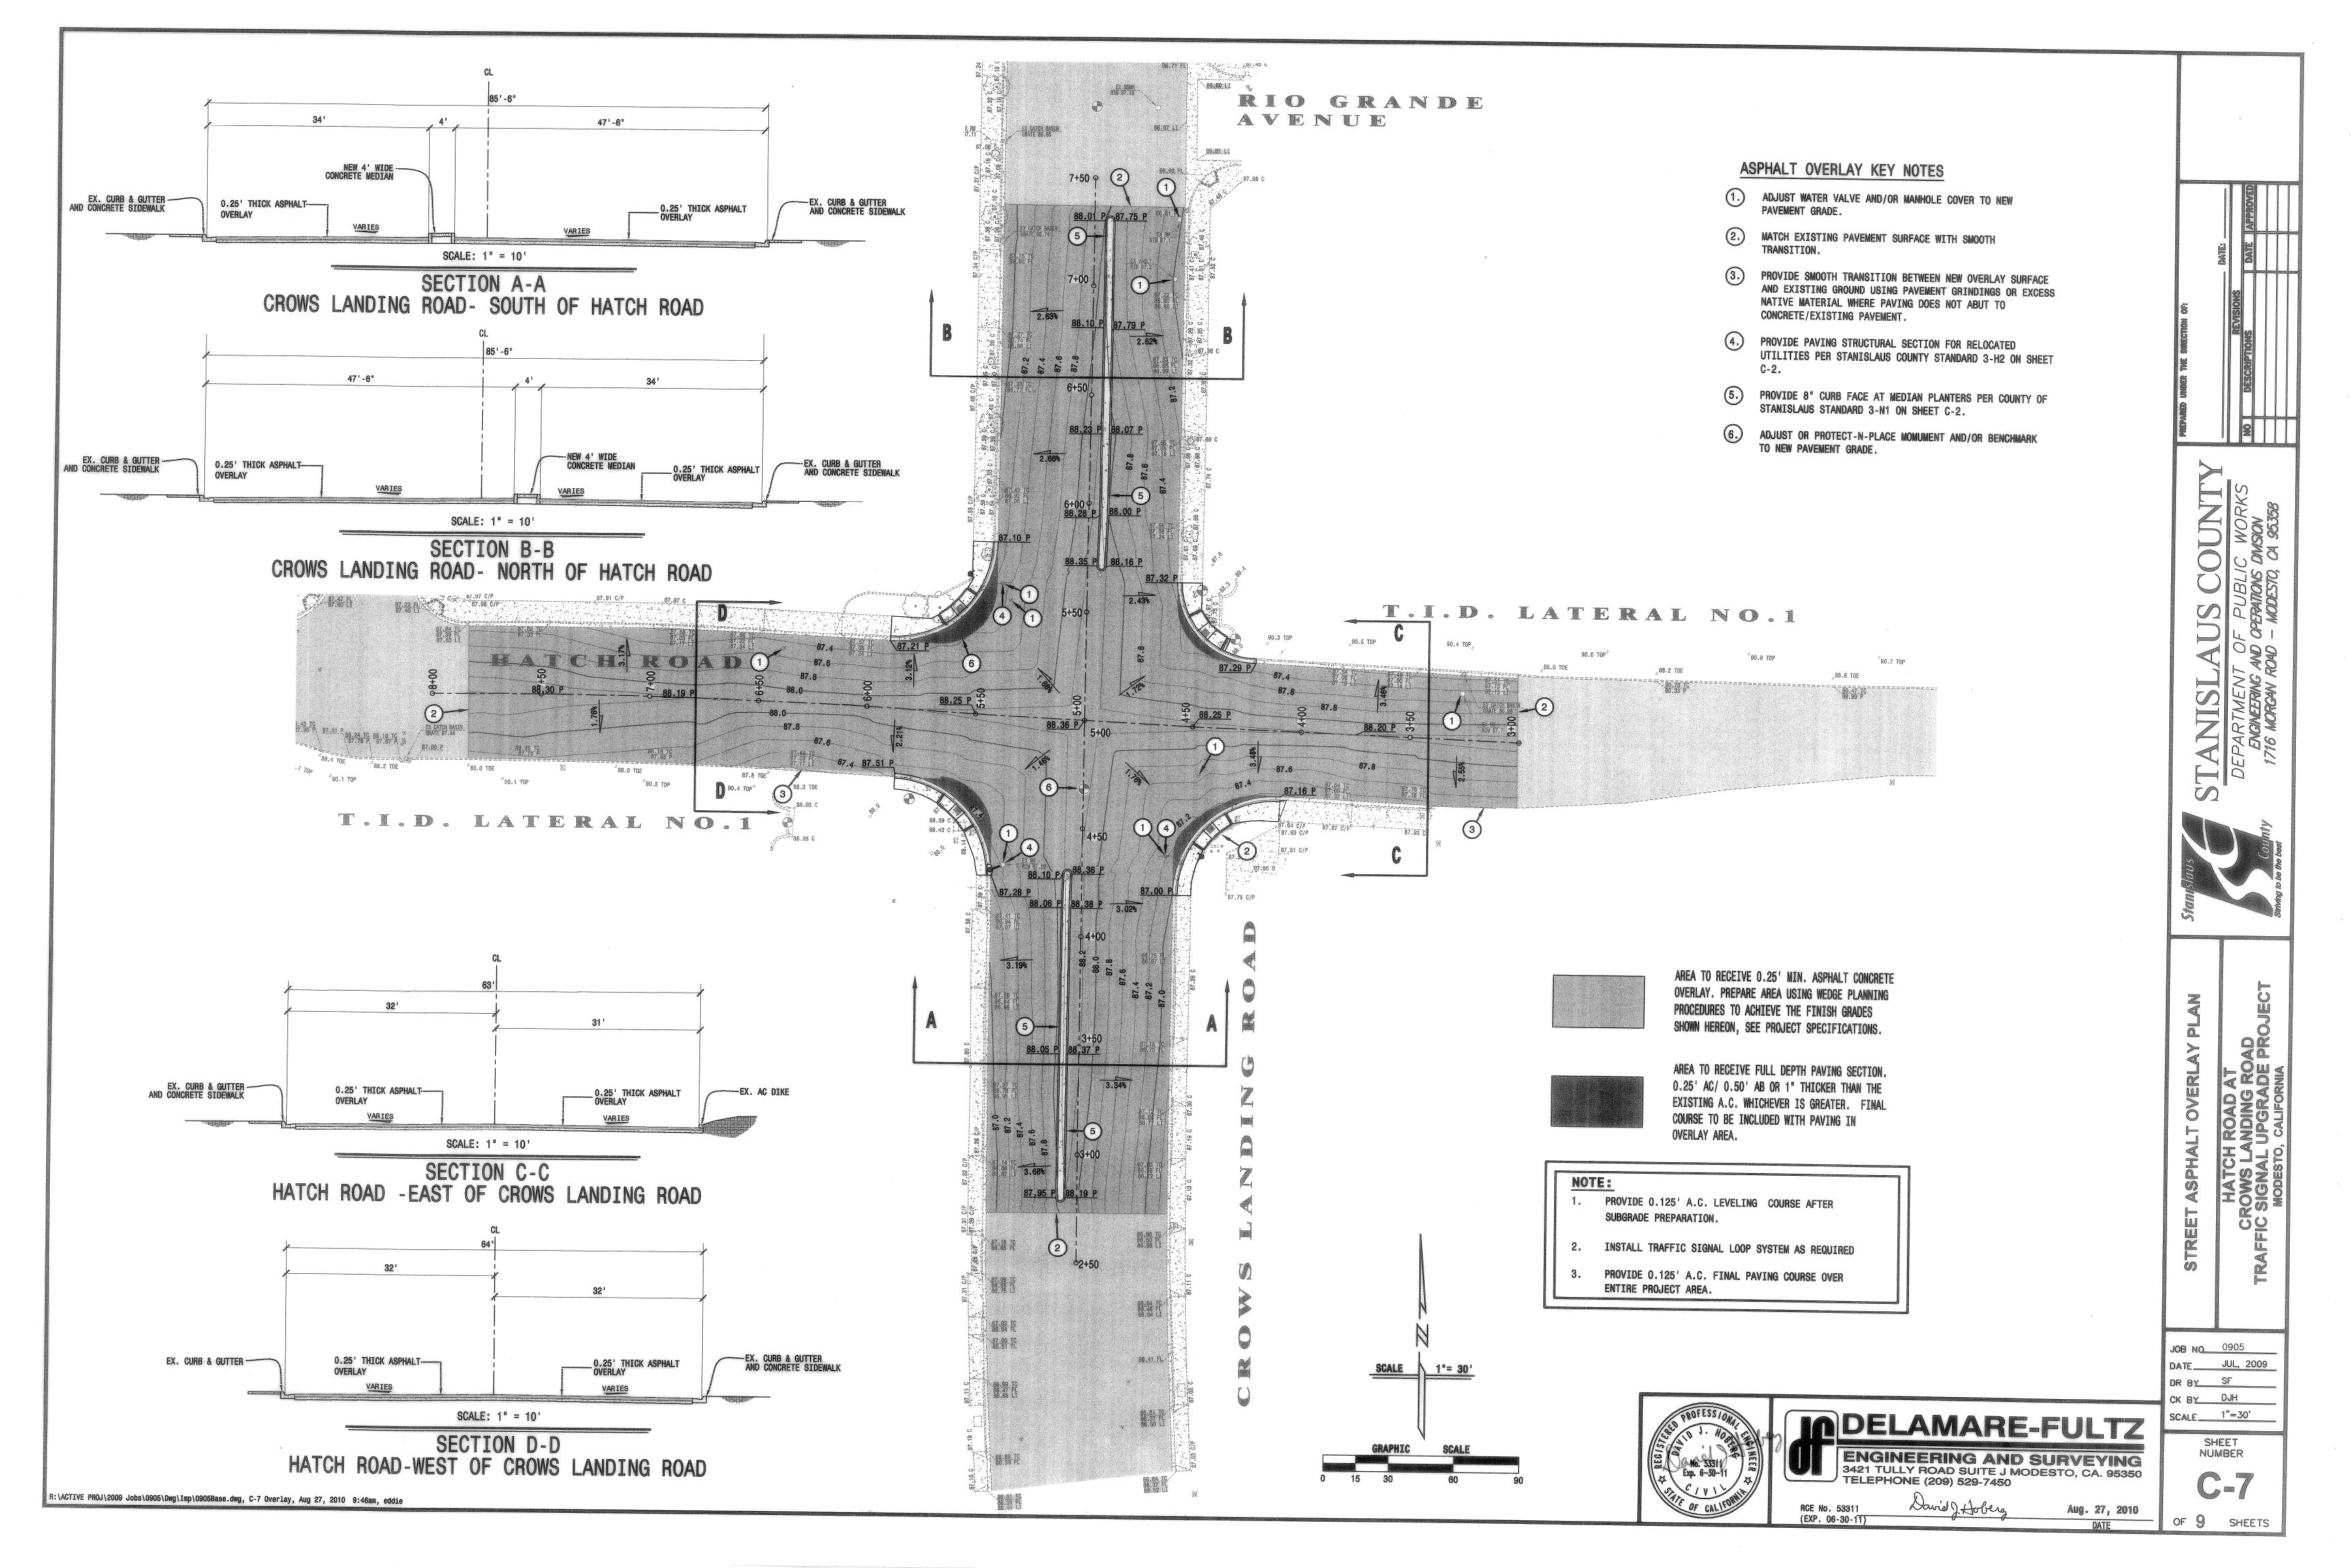1. SIGNAGE PER THE LATEST EDITION OF THE STATE OF CALIFORNIA MANUAL OF UNIFORM TRAFFIC CONTROL DEVICES.

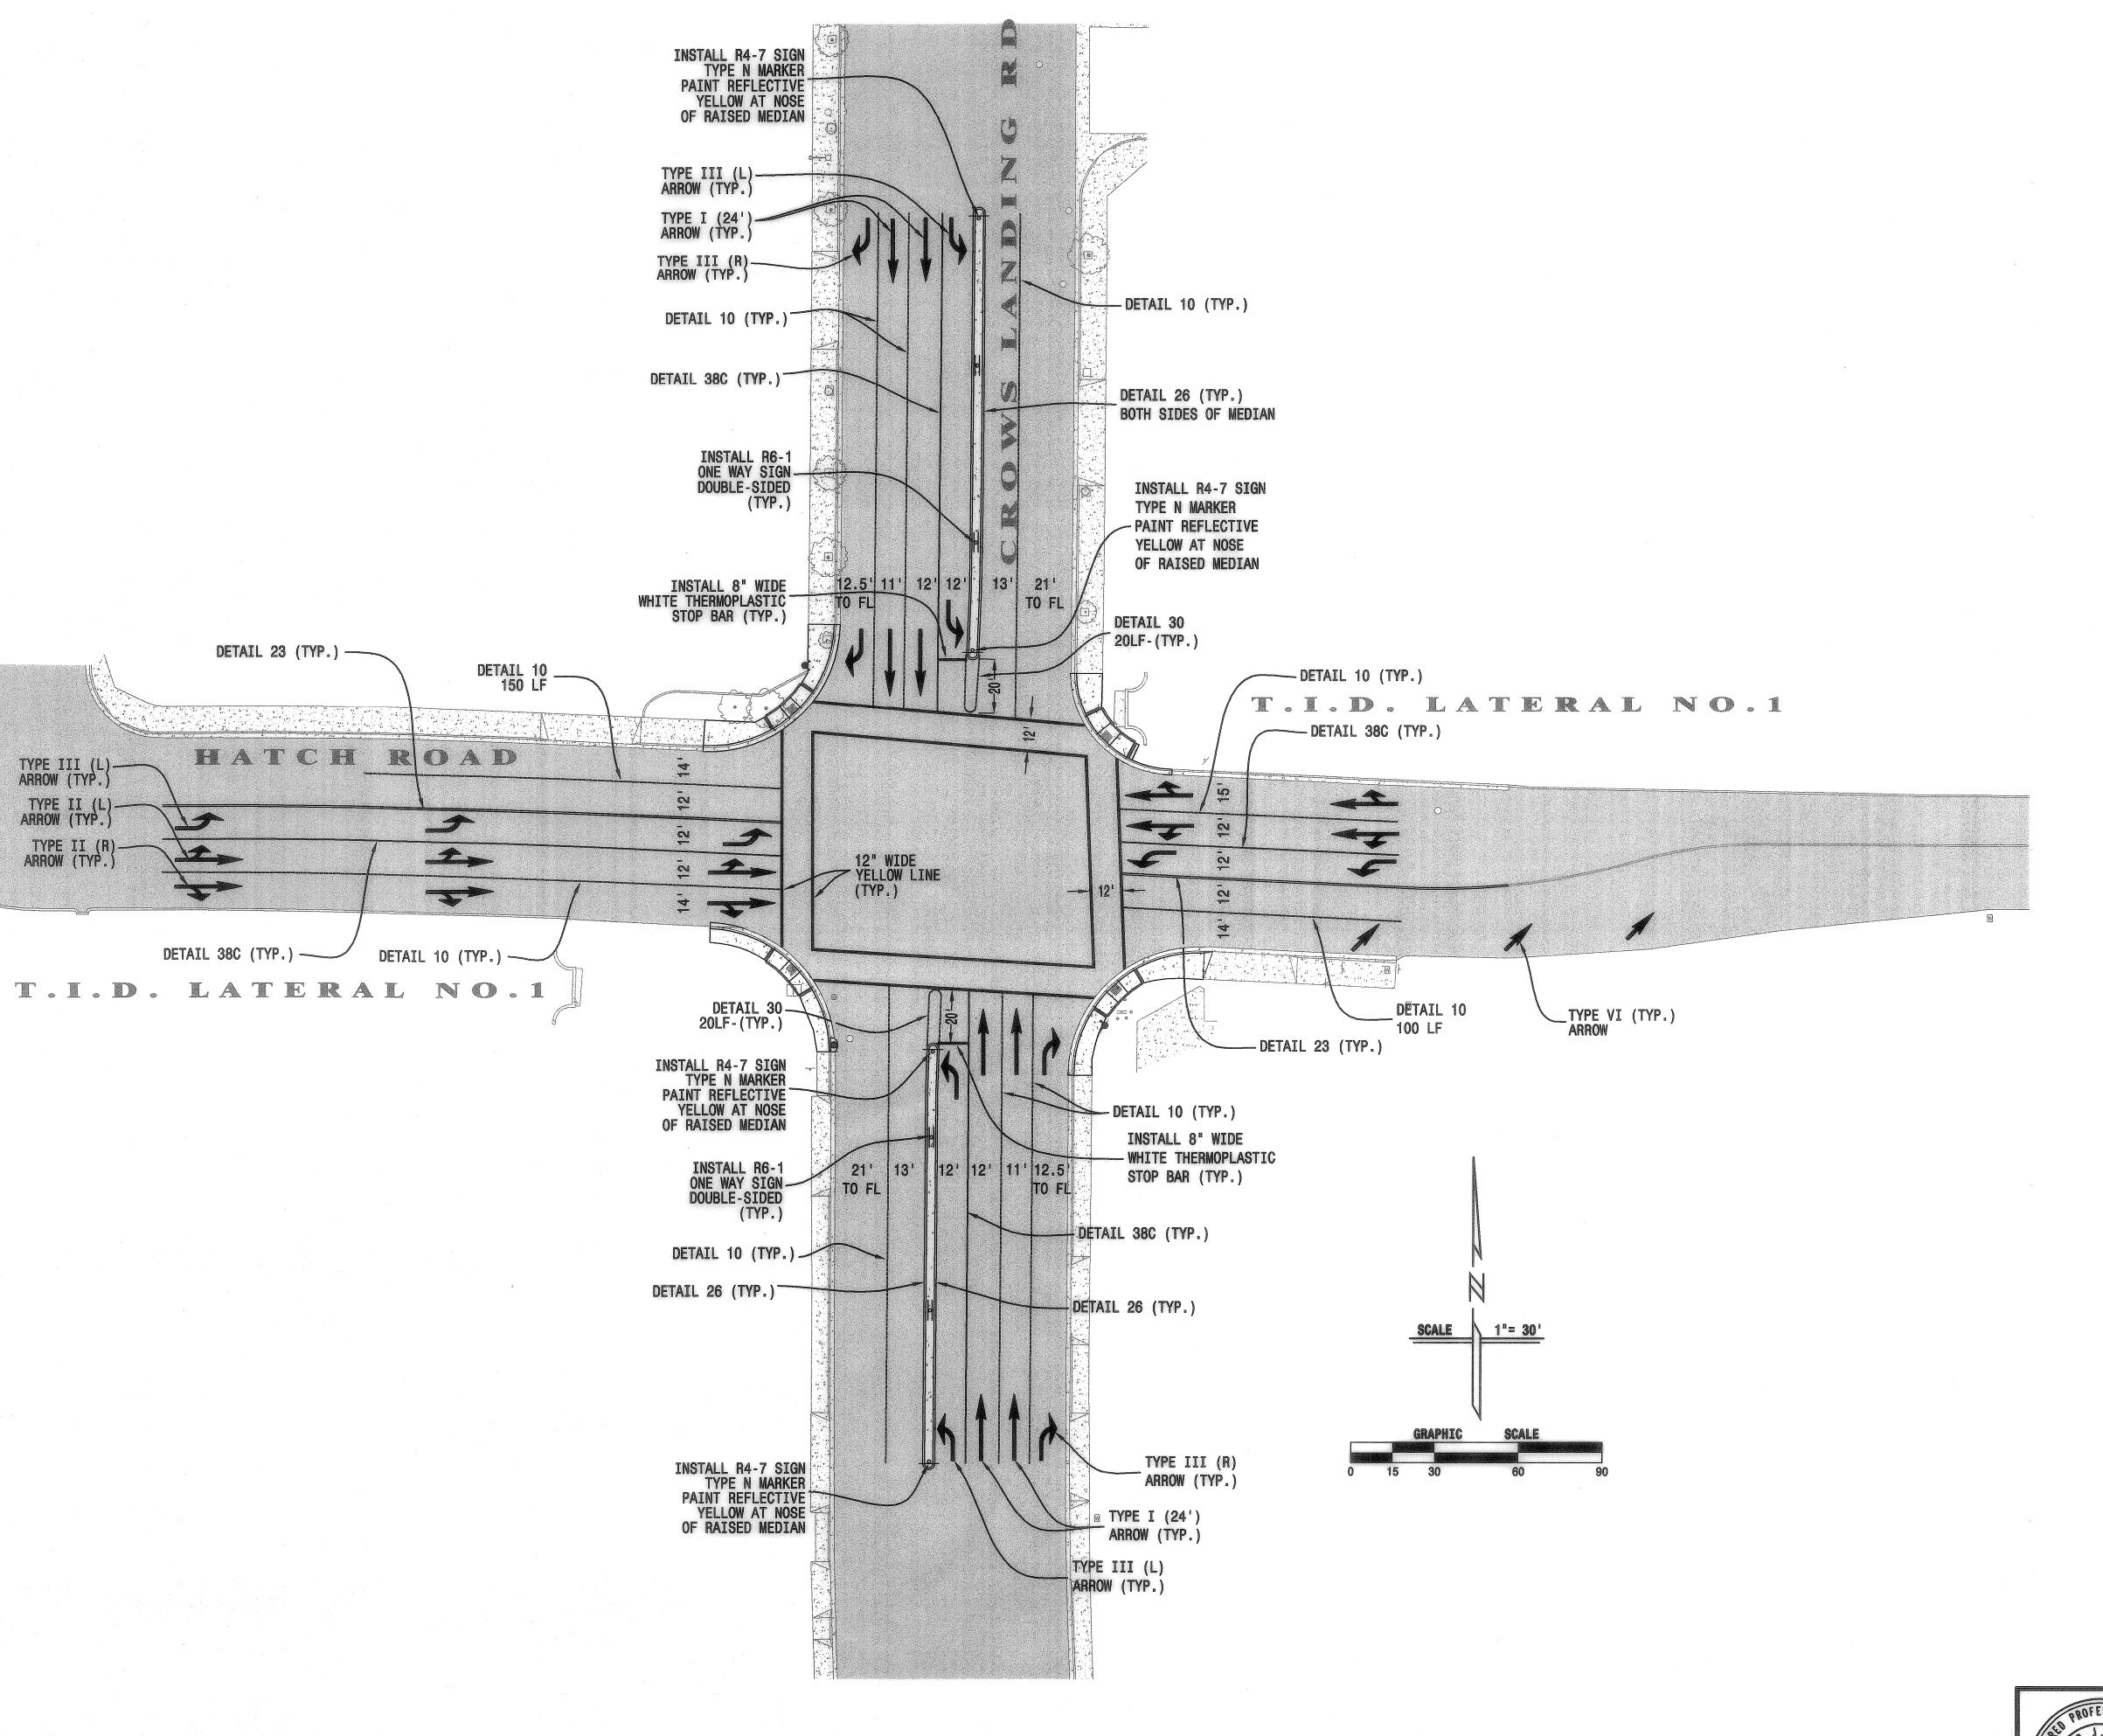2. CONTRACTOR SHALL BE RESPONSIBLE FOR PROVIDING A TRAFFIC CONTROL

3. CONTRACTOR SHALL BE RESPONSIBLE FOR REMOVAL OF ALL EXISTING STRIPING AND PAVEMENT MARKINGS WITHIN THE LIMITS OF STRIPING SHOWN HEREON. METHOD OF REMOVAL SHALL BE APPROVED BY THE COUNTY

MARKERS SHALL BE GLASS-FACED.

INSTALLATION.

6. ALL STRIPING AND MARKING DETAILS SHALL BE IN ACCORDANCE WITH THE

SIGNAGE AND STRIPING

PLAN AS REQUIRED BY STANISLAUS COUNTY PUBLIC WORKS DEPARTMENT.

4. ALL STRIPING AND MARKINGS SHALL BE THERMOPLASTIC AND PAVEMENT

5. THE CONTRACTOR SHALL WORK WITH STANISLAUS COUNTY PUBLIC WORKS DEPARTMENT TO ENSURE PROPER LAYOUT OF TRAFFIC STRIPING PRIOR TO

STATE OF CALIFORNIA MANUAL OF UNIFORM TRAFFIC CONTROL DEVICES

7. SIGN POSTS SHALL CONFORM TO STATE OF CALIFORNIA MANUAL OF UNIFORM TRAFFIC CONTROL DEVICES.

STRIPING

JOB NO 0905 DATE JUL, 2009 DR BY SF CK BY DJH

SCALE 1"=30' SHEET NUMBER


C-8


ENGINEERING AND SURVEYING 3421 TULLY ROAD SUITE J MODESTO, CA. 95350 TELEPHONE (209) 529-7450 David J. Hobers RCE No. 53311 (EXP. 06-30-11)


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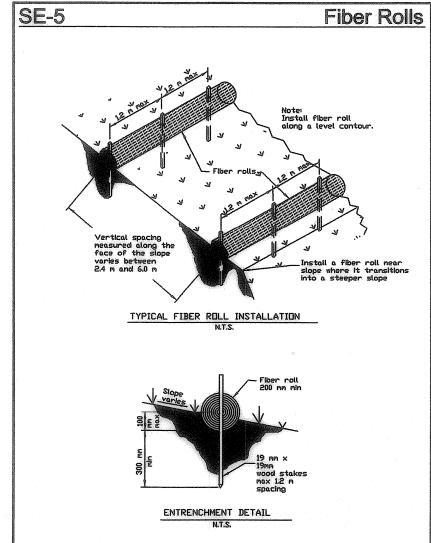
OF 9 SHEETS


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JOB NO 0905 DATE JUL, 2009 DR BY SF CK BY DJH

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of 9 sheets

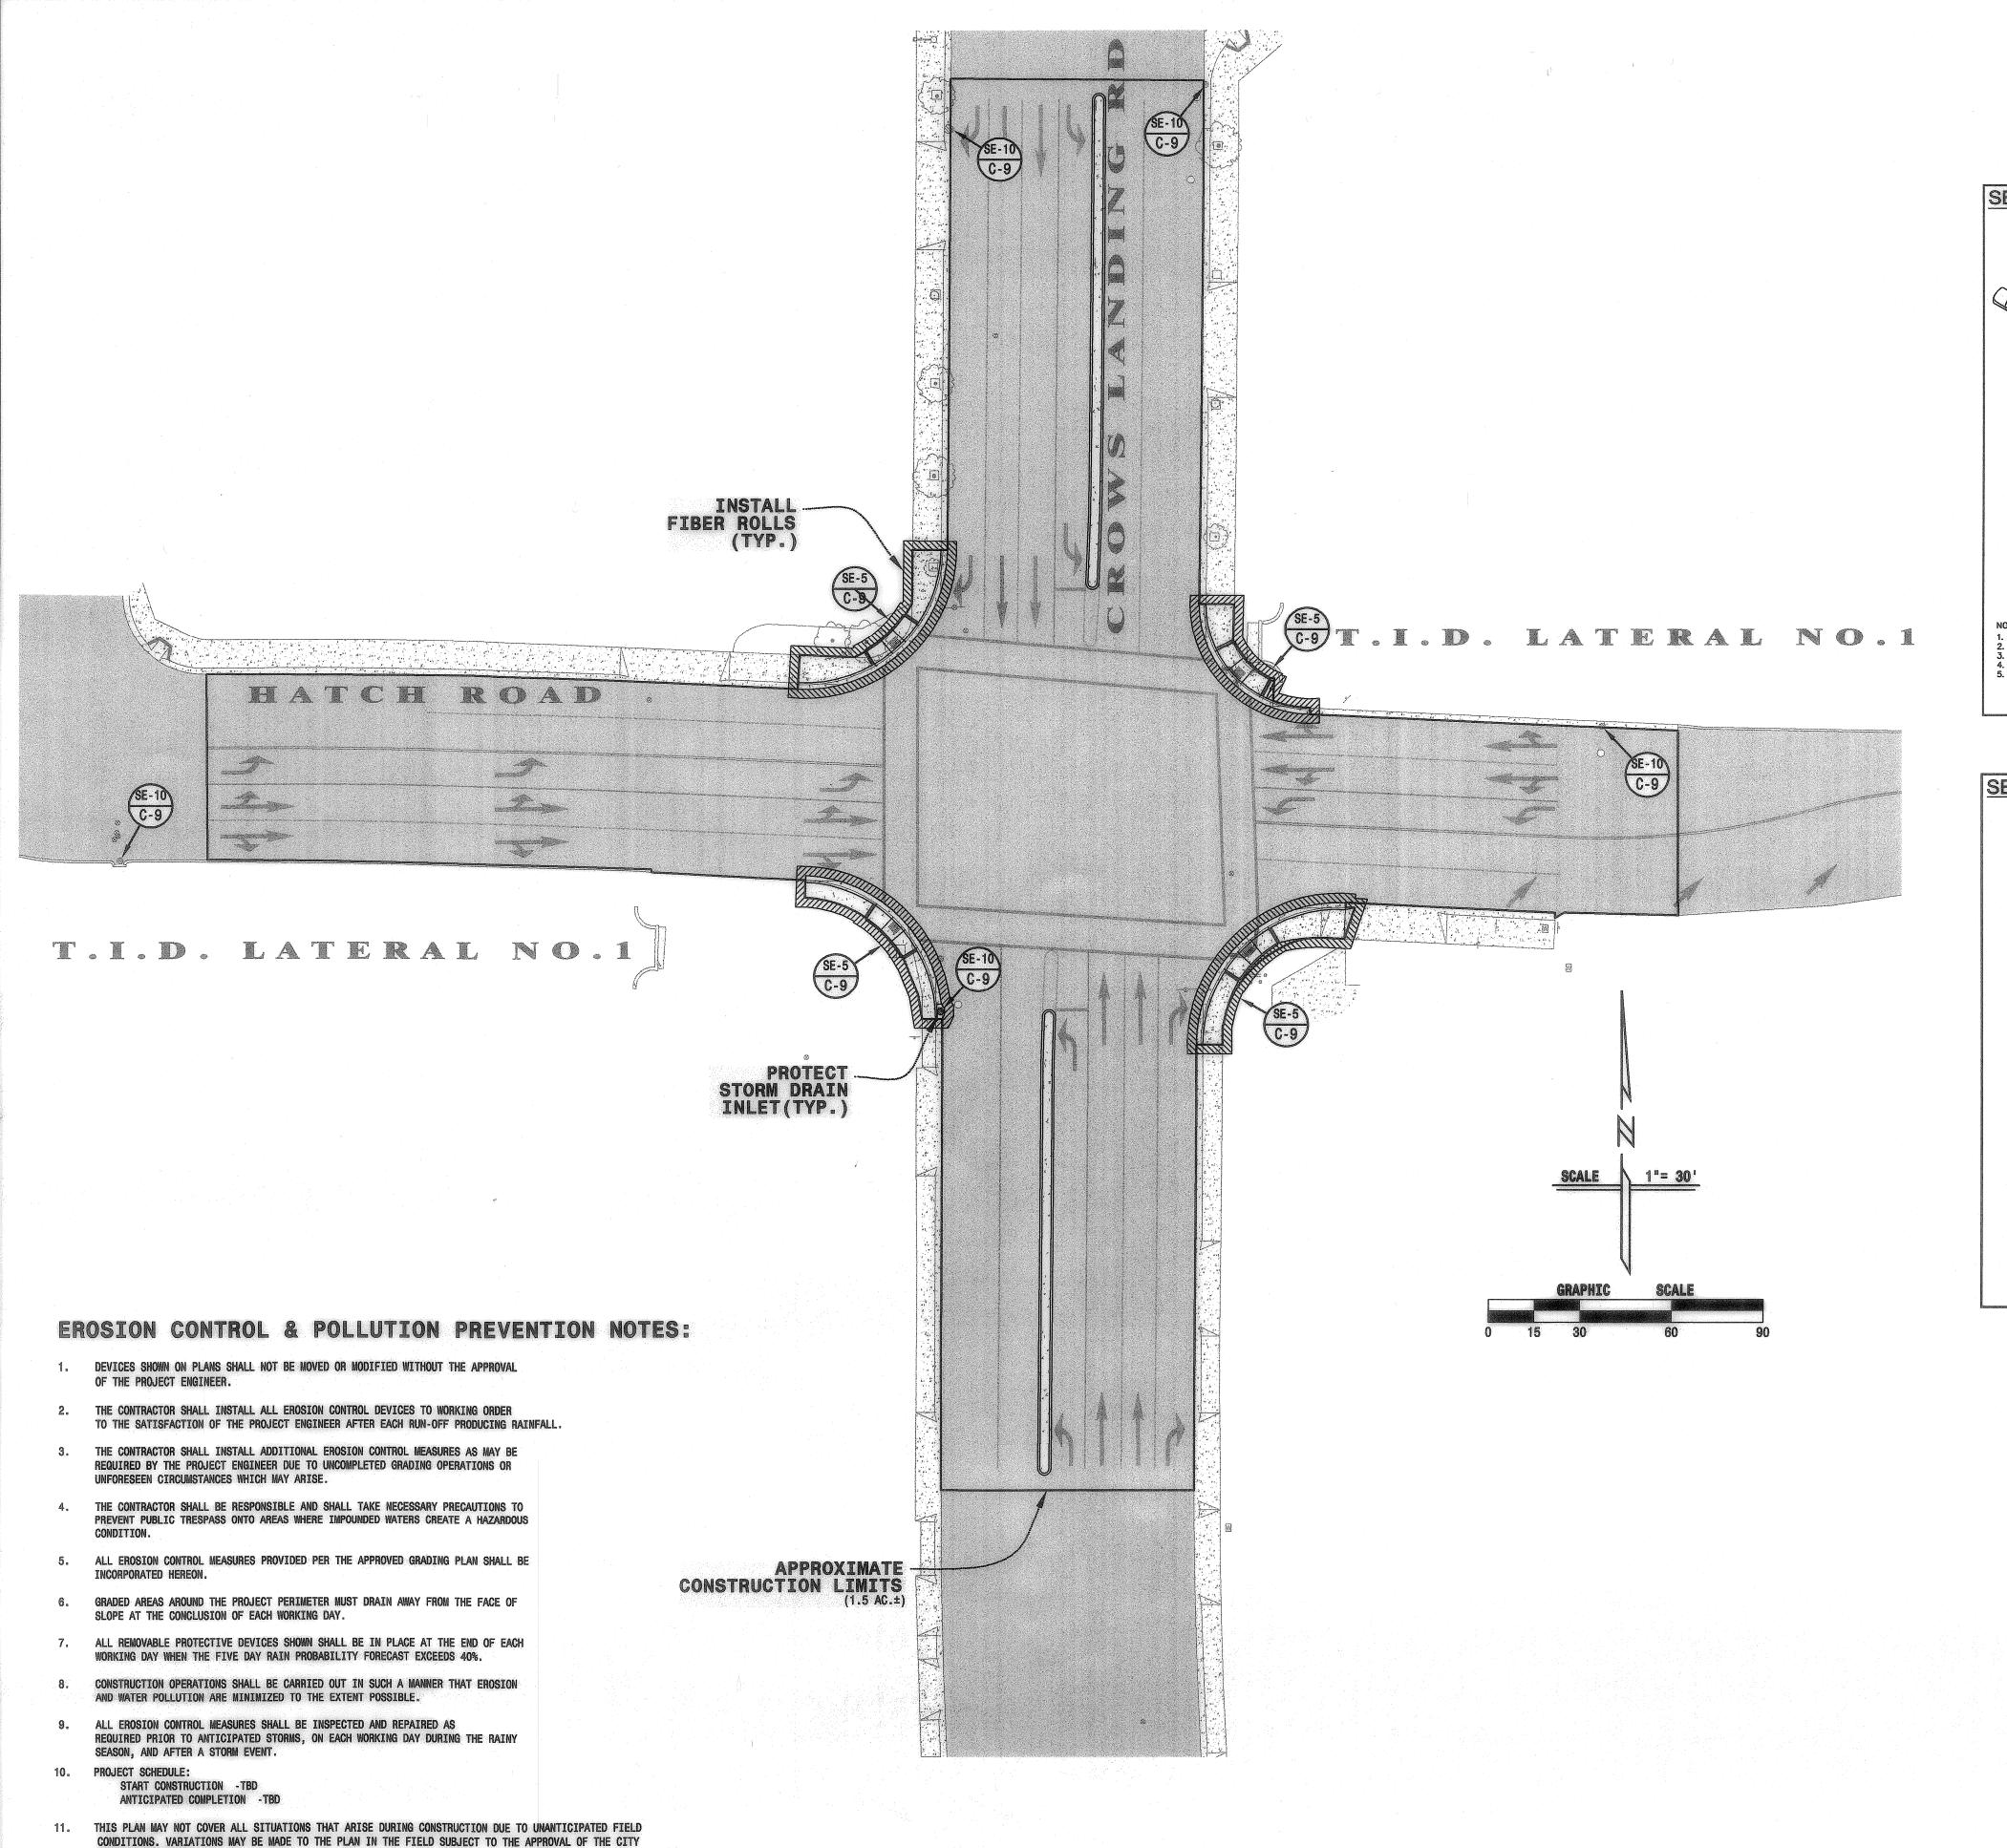ENGINEERING AND SURVEYING 3421 TULLY ROAD SUITE J MODESTO, CA. 95350 TELEPHONE (209) 529-7450 David J. Hobers RCE No. 53311 (EXP. 06-30-11)

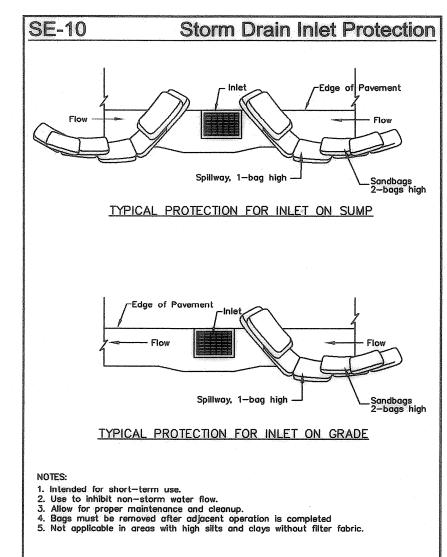**DELAMARE-FULTZ** 

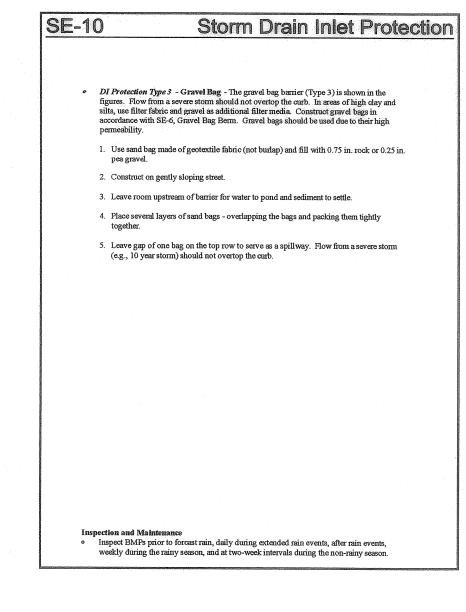
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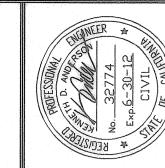
THE REQUIRED NOTIFICATIONS TO THE OWNER.

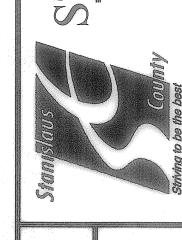12. IF A SPILL, LEAK, BREACH OR MALFUNCTION OF A BMP OCCURS THAT MAY HAVE RELEASED A NON-VISIBLE

POLLUTANT, THE CONTRACTOR SHALL CLEANUP THE INCIDENT AND MONITOR BEFORE AND DURING THE NEXT

STORM IN ACCORDANCE WITH THE SWPPP. THE CONTRACTOR SHALL DOCUMENT THESE ACTIONS, AND MAKE



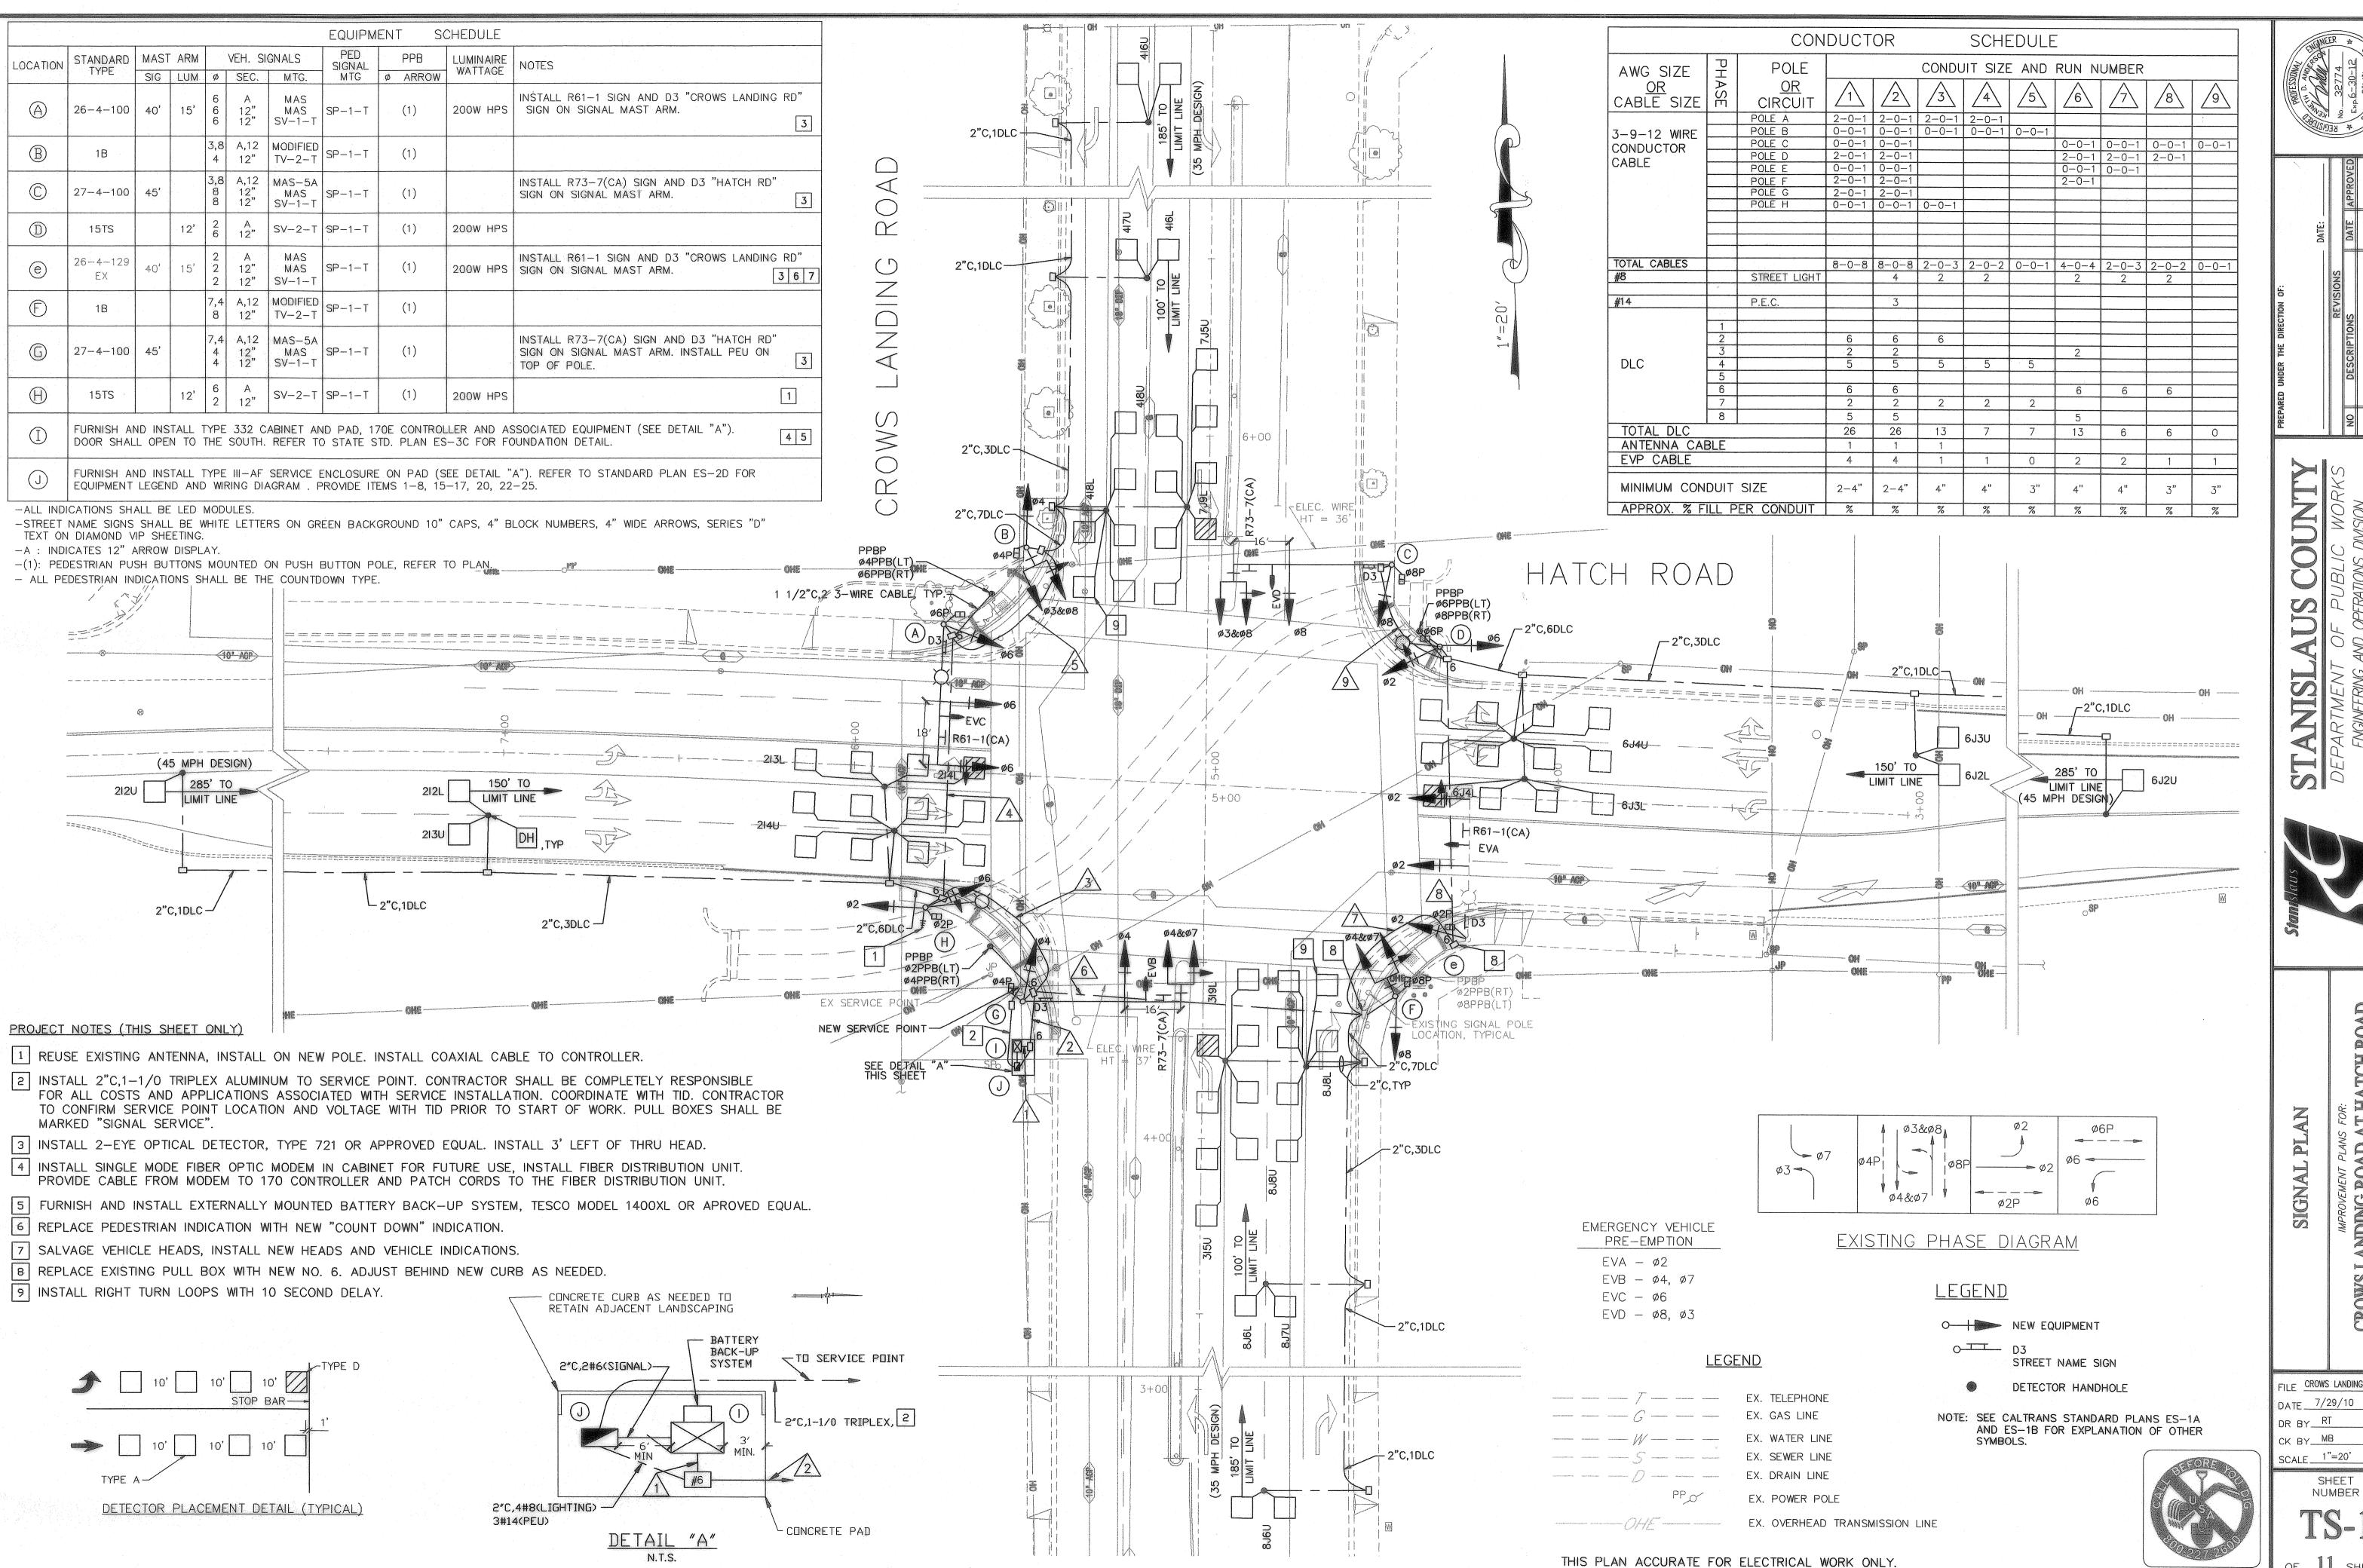








FILE CROWS LANDING&HATCH

SHEET NUMBER

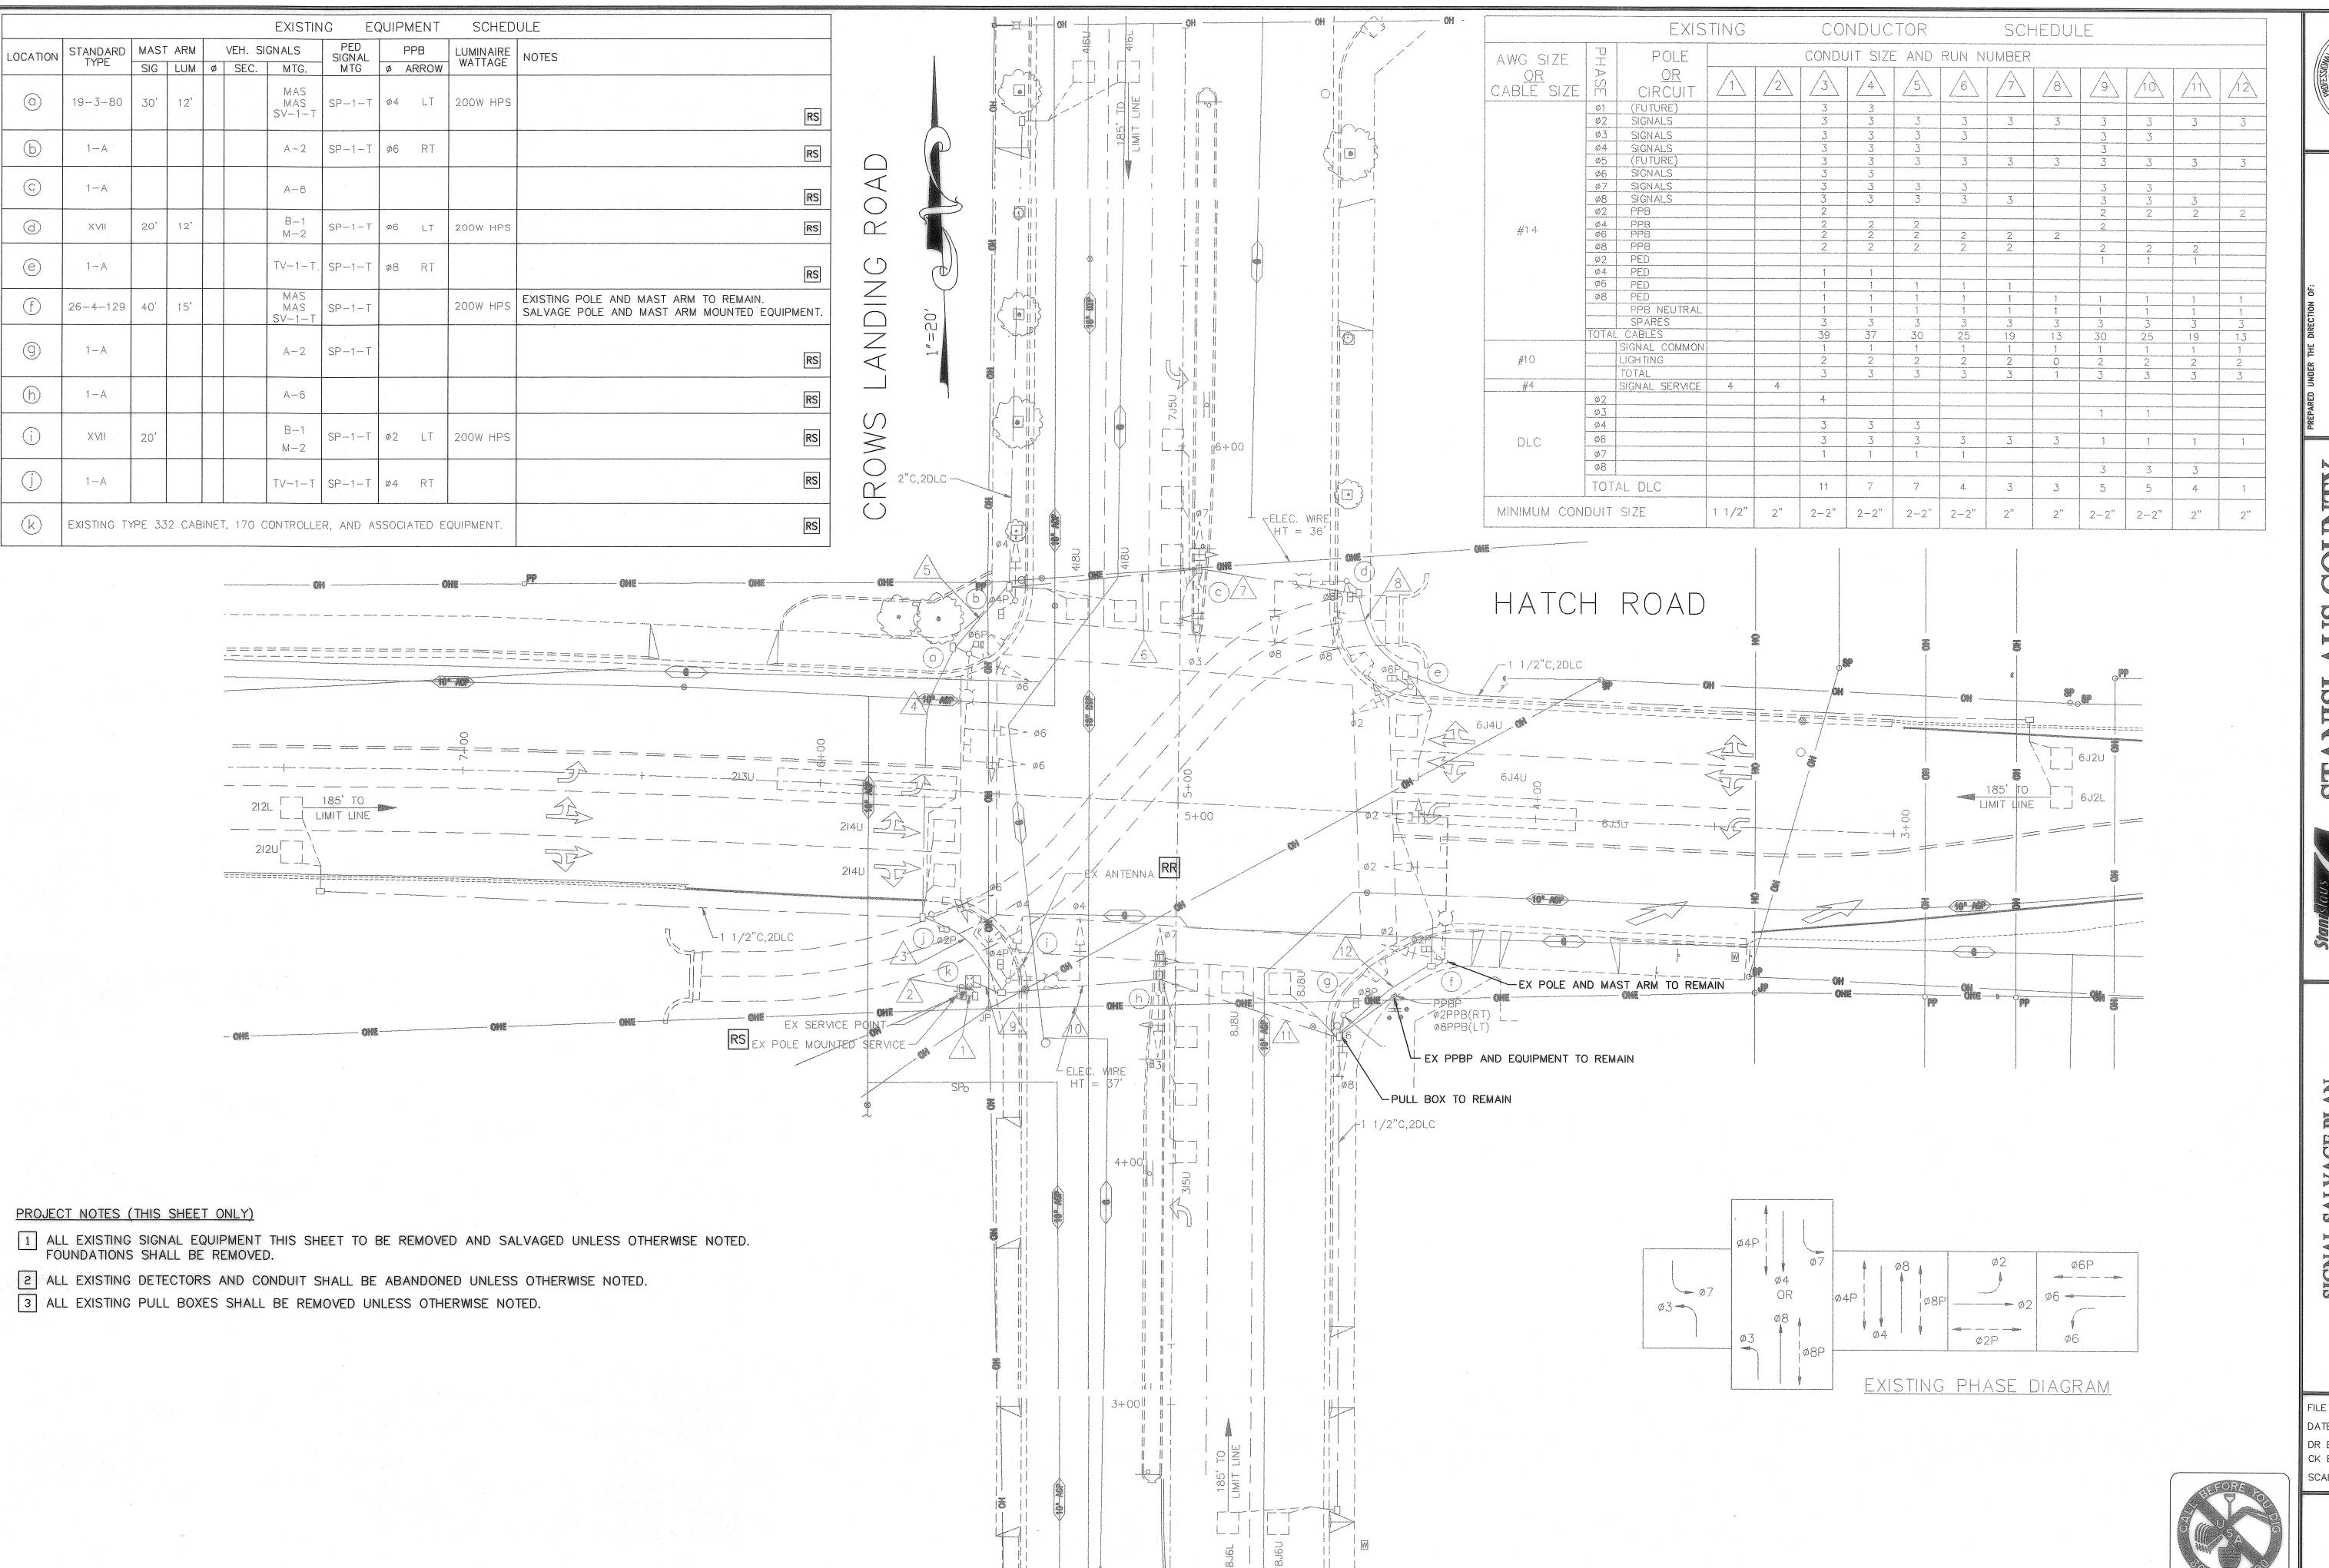

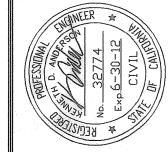

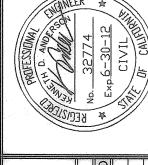



FILE CROWS LANDING&HATCH DATE 7/29/10 DR BY\_RT CK BY MB

SCALE 1"=20' SHEET NUMBER

of 11 sheets

THIS PLAN ACCURATE FOR ELECTRICAL WORK ONLY.

# DECLARATION OF PUBLICATION (C.C.P. \$2015.5)

# COUNTY OF STANISLAUS STATE OF CALIFORNIA

I am a citizen of the United States and a resident Of the County aforesaid; I am over the age of Eighteen years, and not a party to or interested In the above entitle matter. I am a printer and Principal clerk of the publisher of THE MODESTO BEE, printed in the City of MODESTO, County of STANISLAUS, State of California, daily, for which said newspaper has been adjudged a newspaper of general circulation by the Superior Court of the County of STANISLAUS, State of California, Under the date of February 25, 1951, Action No. 46453; that the notice of which the annexed is a printed copy, has been published in each issue there of on the following dates, to wit:

INVITATION TO CONTRACTORS

"Hatch Road at Crows Landing Road Traffic Signal Upgrade"
Owner is Stanislaus County, Modesto CA; Estimated construction cost for this project is \$463,892.50; Sealed bids are due before 2:00 P.M., April 6, 2011, to the Clerk of the Board of Supervisors, 1010 10th Street, Ste. 6500, Modesto, CA 95354; Project contact Denis Bazyuk bazyukd@stancounty.com or Fax No. (209) 541-2509. Work to be accomplished includes signal upgrade and intersection improvements as directed by the Engineer and other such items not mentioned herein that are required by the plans and specifications. Plans and specifications are available for purchase from Modesto Reprographics, Modesto, CA, (209) 544-2400 and can be viewed at viewed www.modestoplanroom.com under "Public Jobs". Pub Dates Mar. 7, 14, 21, 2011

Mar 07, 2011, Mar 14, 2011, Mar 21, 2011

I certify (or declare) under penalty of perjury That the foregoing is true and correct and that This declaration was executed at

MODESTO, California on

March 21st, 2011

(By Electronic Facsimile Signature)

Marie Dieckmann